## VILLAGE OF OSCEOLA PLAN COMMISSION MEETING

**Date:** Tuesday June 6th, 2023

**Time:** 7:00 p.m.

Place: Large Conference Room (Rm 205)

310 Chieftain Street Osceola WI 54020

## PLAN COMMISSION AGENDA

- 1. Call the meeting to order
- 2. Approval of agenda
- 3. Approval of Minutes
  - a. May 2<sup>nd</sup> 2023
  - b. May 24th 2023
- 4. Appointment of Board Chair
- 5. Quality Polymers Site Plan Review See Attachments
- 6. Discussion and possible action re:
  - a. **Public Hearing** relating to filling or grading more than 10,000 square feet of land pursuant to Village Code § 217-8E for the property located at 301 River Street in the Village.
  - b. **Public Hearing** relating to multi-family residential uses within mixed-use buildings and/or developments at 301 River Street in the Village pursuant to Village Ordinance 2023-04.
  - c. **Public Hearing**, relating to increasing the maximum structure height to up to 45 feet pursuant to Village Code § 217-7(4)(a) for the property located at 301 River Street in the Village.
- 7. Close of the Public Hearing portion of the meeting.
- 8. Possible recommendation to the Village Board on Public Hearing subject matter.
  - a. Staff Report in Attachment with Plans
- 9. Comp Plan Discussion
- 10. Public Input on Regular Agenda Discussion
- 11. Allow Sale of Land in Industrial Park
- 12. Future agenda items and updates
- 13. Adjourn

**NOTE**: It is possible that members of other governmental bodies of the municipality may be present at the above scheduled meeting to gather information about a subject over which they have decision-making responsibility. No action will be taken by any governmental body at the above-stated meeting other than the governmental body specifically referred to above in this notice.

## PLAN COMMISSION MEETING PROCEEDINGS May 2nd, 2023

The Plan Commission of the Village of Osceola met on May 2nd, 2023 to hold a regular monthly board member Norenberg called the meeting to order at 7:00 p.m.

Present: Deb Rose, Kim O'Connell, Bill Chantelois V, Dennis Tomfohrde, Tyler Norenberg

Excused: Deb Rose, Rob Bullard Staff present: Devin Swanberg

Others present: Peter Paidar, Nealy Yakes, Sandy Caravelli, Thomas Caravelli, Pat Brown,

Jamie Muscha

Motion to approve the agenda was made by O'Connell, second by Chantelois motion passed 4-0

Motion to approve the minutes of the March and April commission meeting was made by Tomfohrde and seconded by O'Connell motion passed 4-0

Mike Viebrock presented the possibility of developing Meadowlark lane with the phase plan from the preliminary plat from 1996. He wanted to get this before the board so they are aware of the issues and to inform them of how the development would be laid out. Administrator Swanberg mentioned that currently they are working with the FAA and the airport to see if Airport Road is Shared or for Airport business only. There were discussions on the utilities and the overall layout of the plan. No action was requested at this time as more time is needed for development and planning.

Administrator Swanberg brought forward a lot to potentially sell for development around the southeast side of the airport. Chantelois made a motion to pursue to sell if it is allowable motion seconded by Tomfohrde motion passed 4-0

Future agenda items and updates – Discussion on the Comp Plan at the June Meeting and Baird is coming to the Regular Village Board meeting May 16<sup>th</sup> to do a presentation on TIF/TID to teach the board and community how it works and why it is used.

Meeting Adjourned at 7:48

Respectfully submitted by Devin Swanberg Village Administrator

## PLAN COMMISSION MEETING PROCEEDINGS May 24th, 2023

The Plan Commission of the Village of Osceola met on May 24th, 2023 to hold a special board meeting member Rose called the meeting to order at 6:02 p.m.

Present: Deb Rose, Kim O'Connell, Dennis Tomfohrde, Tyler Norenberg, Bruce Gilliland, Deb

Rose, Rob Bullard

Excused: Bill Chantelois V

Staff present: Devin Swanberg, Angela Poppenhagen

Others present: Peter Paidar, Nealy Yakes, Sandy Caravelli, Thomas Caravelli, Pat Brown, Lisa

Curry, Holly Walsh, Betsy Kremser, Hale, Arvid Maki, Brad Lutz, Sean Bohan, Eliane

Kopischke, Kent Jefferson, Dan Guenther, John Harriss, Dan Hebert

Motion to approve the agenda was made by Bullard, second by Gilliland motion passed 6-0

Sean Bohan from AEC presented the Osceola Bluffs engineer plan to the planning committee. The project site is 4.6 acres. Currently the impervious surface is 96,000 sq ft, the new plan will decrease that to 64,000 sq ft. The site plan meets all required setbacks from NR 118 and stay out of the 40-foot setback that the current structure is over. The storm water will be managed by 3 storm ponds where there is currently impervious surface. Three of these are bioretention and the third is dry pond. This will decrease peak rates 60% to the west and 80% to the south. The ponds clean water and follow all state and village ordinances. Using these measures, it will lower the peak rates create less erosion and better water quality.

John Harriss from HA Architecture presented the site plan and the narrative for the Osceola Bluff Development with Dan Hebert of Gaughan. They presented that they would need three conditional use permits, one for height, one for disturbing 10,000 sq ft and one for first floor residential in the B1 district. They have achieved 1.7 parking spaces for the building on the site and will not need contracted parking. The site has 112 underground parking spaces with a dog washing station and bike storage. They will work with SHPO while excavating to ensure proper protocol and being followed if anything of significance is found while excavating. They are using a flat roof design to maximize the units and for better water control on the site. When asked why they are using 9-foot ceilings not 8 it is now the industry standard.

City Engineer confirmed that the height of the building is 44 feet 8 inches.

The colors were chosen to be visually inconspicuous with the bluff and trees they called it stealth design. They have no desire to cut trees to keep the natural appeal. They met with the fire chief to discuss and address any issues they might have. The lighting on the site will not emit light pollution into the skies and be localized and down. When asked why they site and not somewhere else the response was because of the uniqueness this site provides and the proximity to downtown. Norenberg also asked why, where when there are conflicts with code and comp plan. Response was the village is desperate for good sustainable housing.

The meeting was adjourned 7:25 pm

Respectfully submitted by Devin Swanberg Village Administrator

## PROPOSED PROJECT: QUALITY POLYMERS, INC. OSCEOLA, WI

SHEET #	SHEET TITLE		
G100	COVER SHEET		
G101	GENERAL NOTES		
A101	FOUNDATION PLAN		
A102	FLOOR PLAN		
A201	EXTERIOR ELEVATIONS		
A202	EXTERIOR ELEVATIONS		
A301	BUILDING SECTIONS		
A401	DETAILS		

### CONSULTANTS

GENERAL CONTRACTOR:
NORTHWEST BUILDERS INC.
2063 17 1/2 AVE
RICE LAKE, WI, 54868
PH; (715) 234-7066 FX: (715) 234-9378
CONTACT: JORDAN HEINECKE — PROJECT MANAGER

STRUCTURAL ENGINEERING: RICE LAKE ENGINEERING 15 E. EAU CLAIRE STREET RICE LAKE, WI. 54868 PH: (715) 296-8754 CONTACT: BOB SEXTON

BUILDERING INSPECTOR: WEST WISCONSIN INSPECTION AGENCY PH: (715) 556-3136 CONTACT: BEN CAMPBELL





PROPOSED PROJECT: QUALITY POLYMERS, INC.


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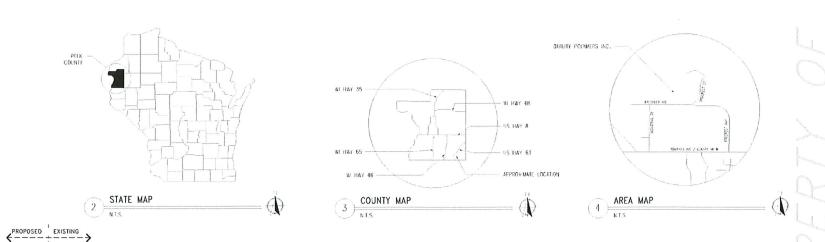
PRELIMINARY 23-043


**COVER SHEET** 

G100

PRELIMINARY



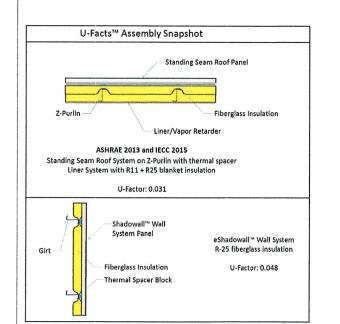

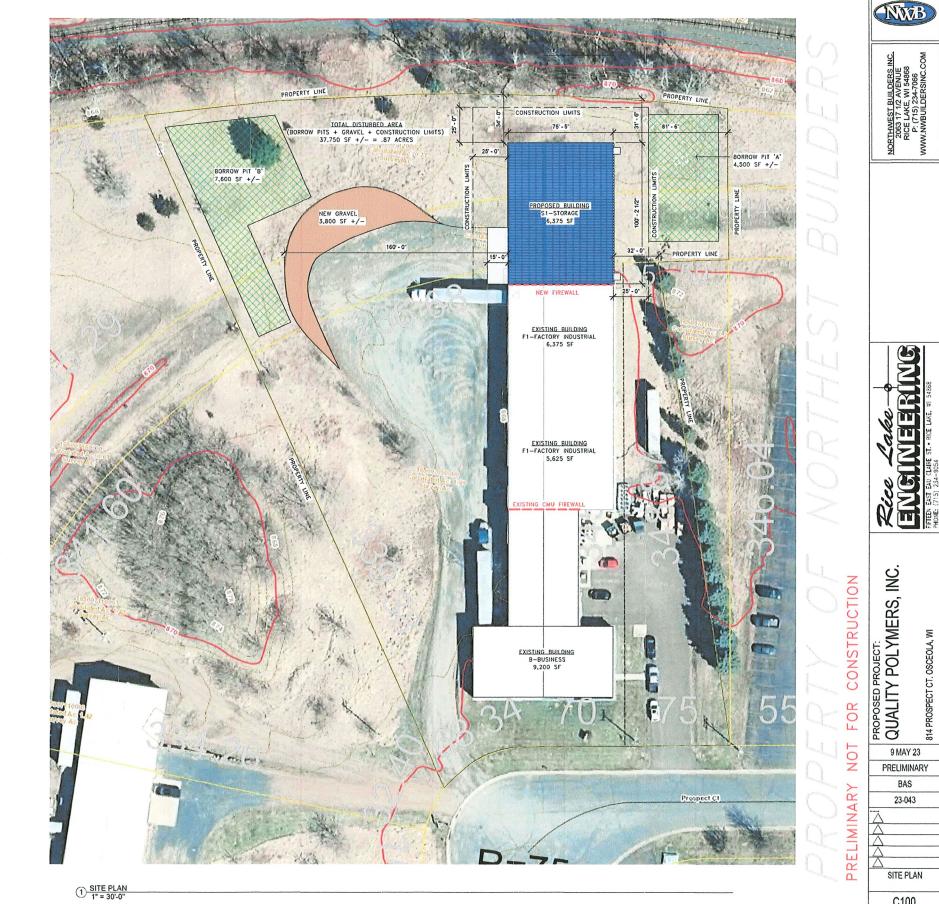


NWB

814 PROSPECT CT. OSCEOLA, WI

PRELIMINARY

C100

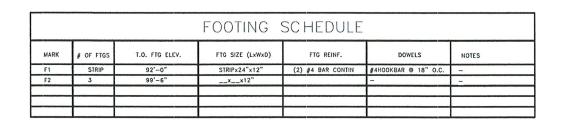

PIER SCHEDULE							
MARK # 0F T.O. PIER PIER SIZE (WxL) VERTICALS TIES T.O. FTG ELEV. DOWELS							
P1		100'-6"		(4) #5 BAR	#3 HOOPS @ 12" O.C.	92'-0"	


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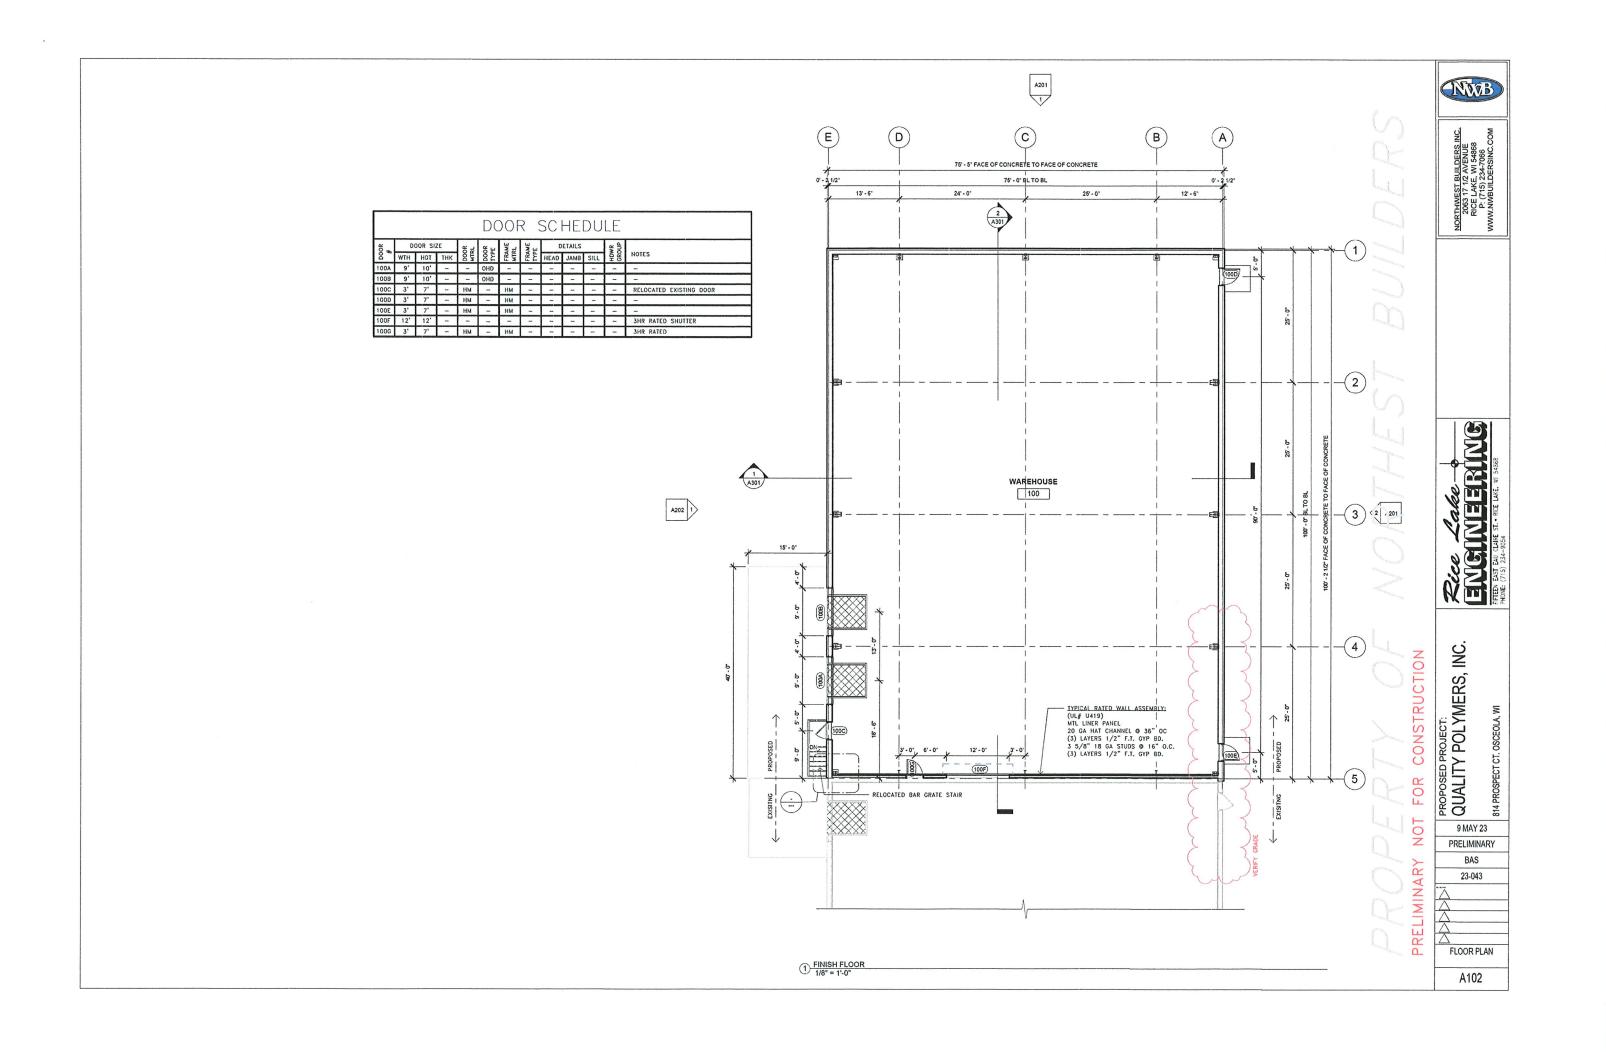
0' - 2 1/2"


2 EXISTING TO NEW WALL DETAIL
3/4" = 1'-0"


FACE OF EXISTING \_


- FACE OF EXISTING CONC WALL




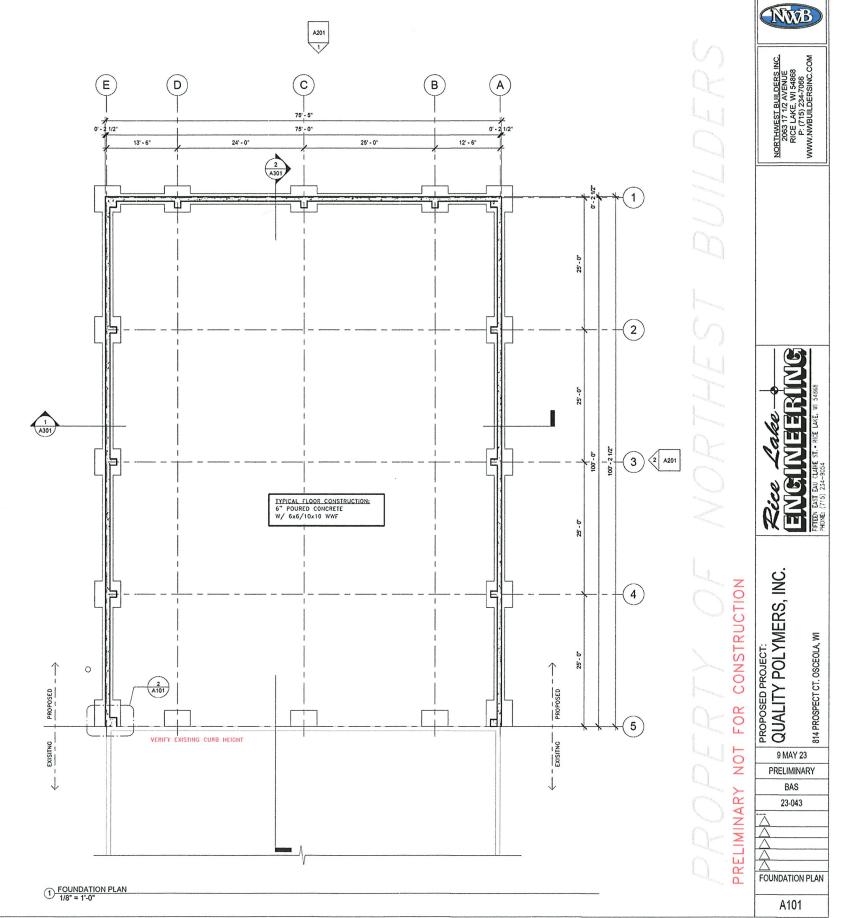

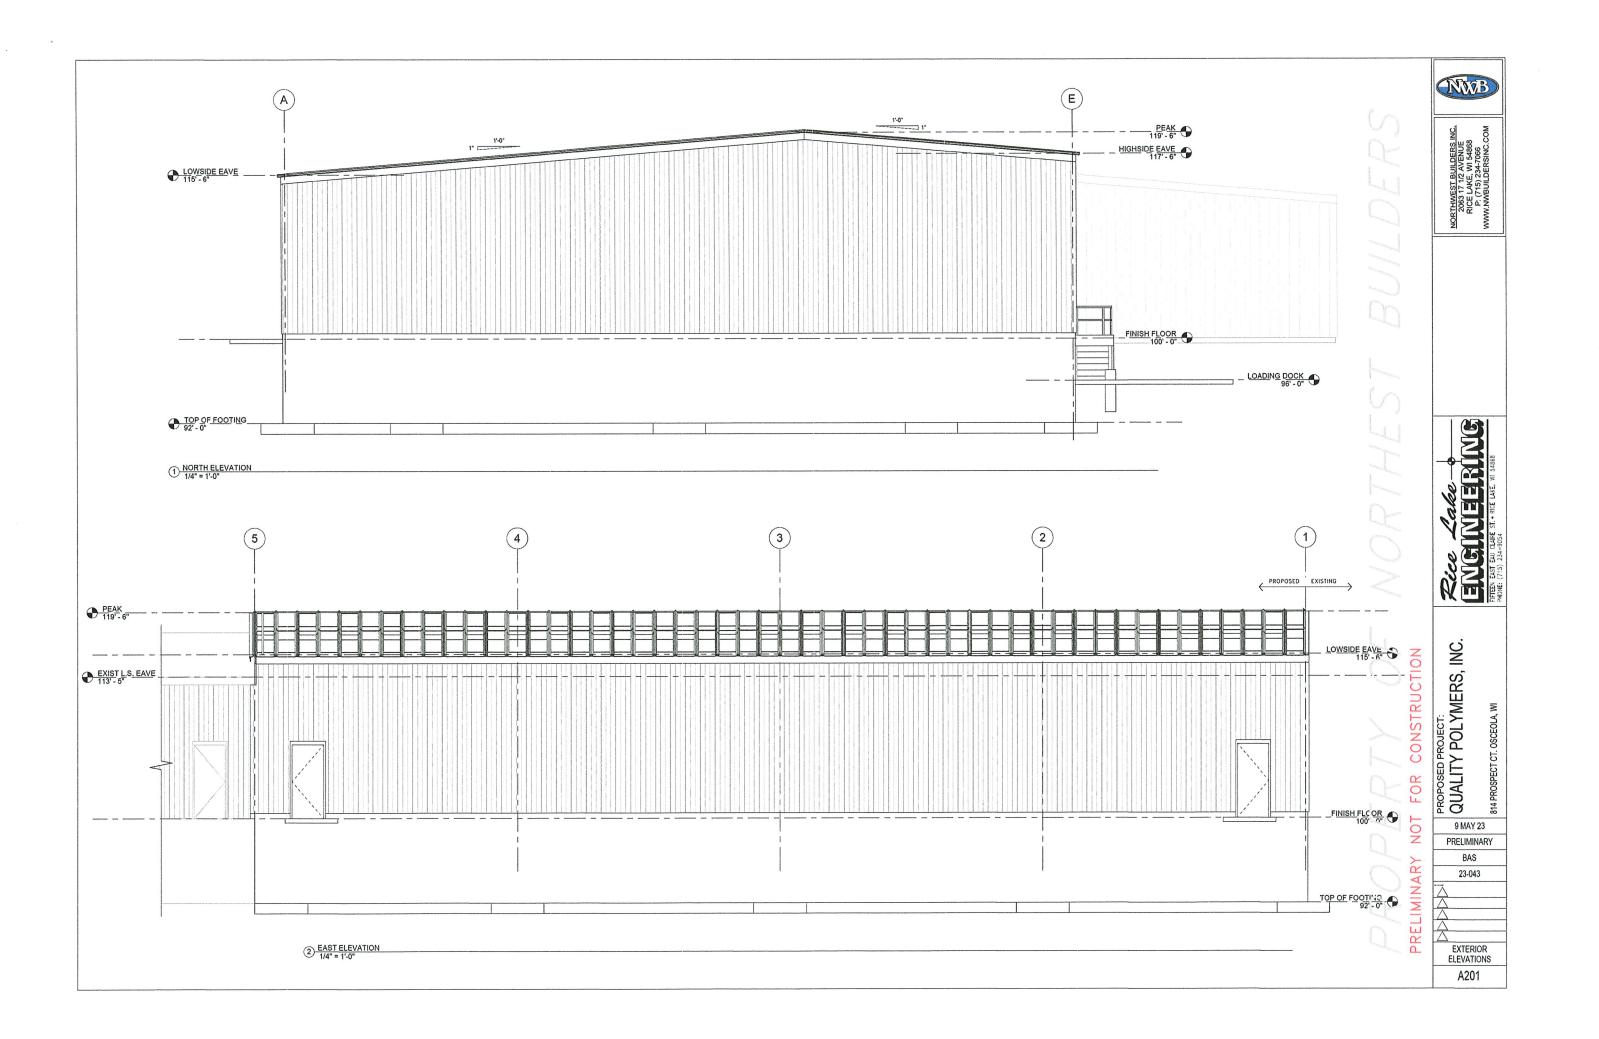

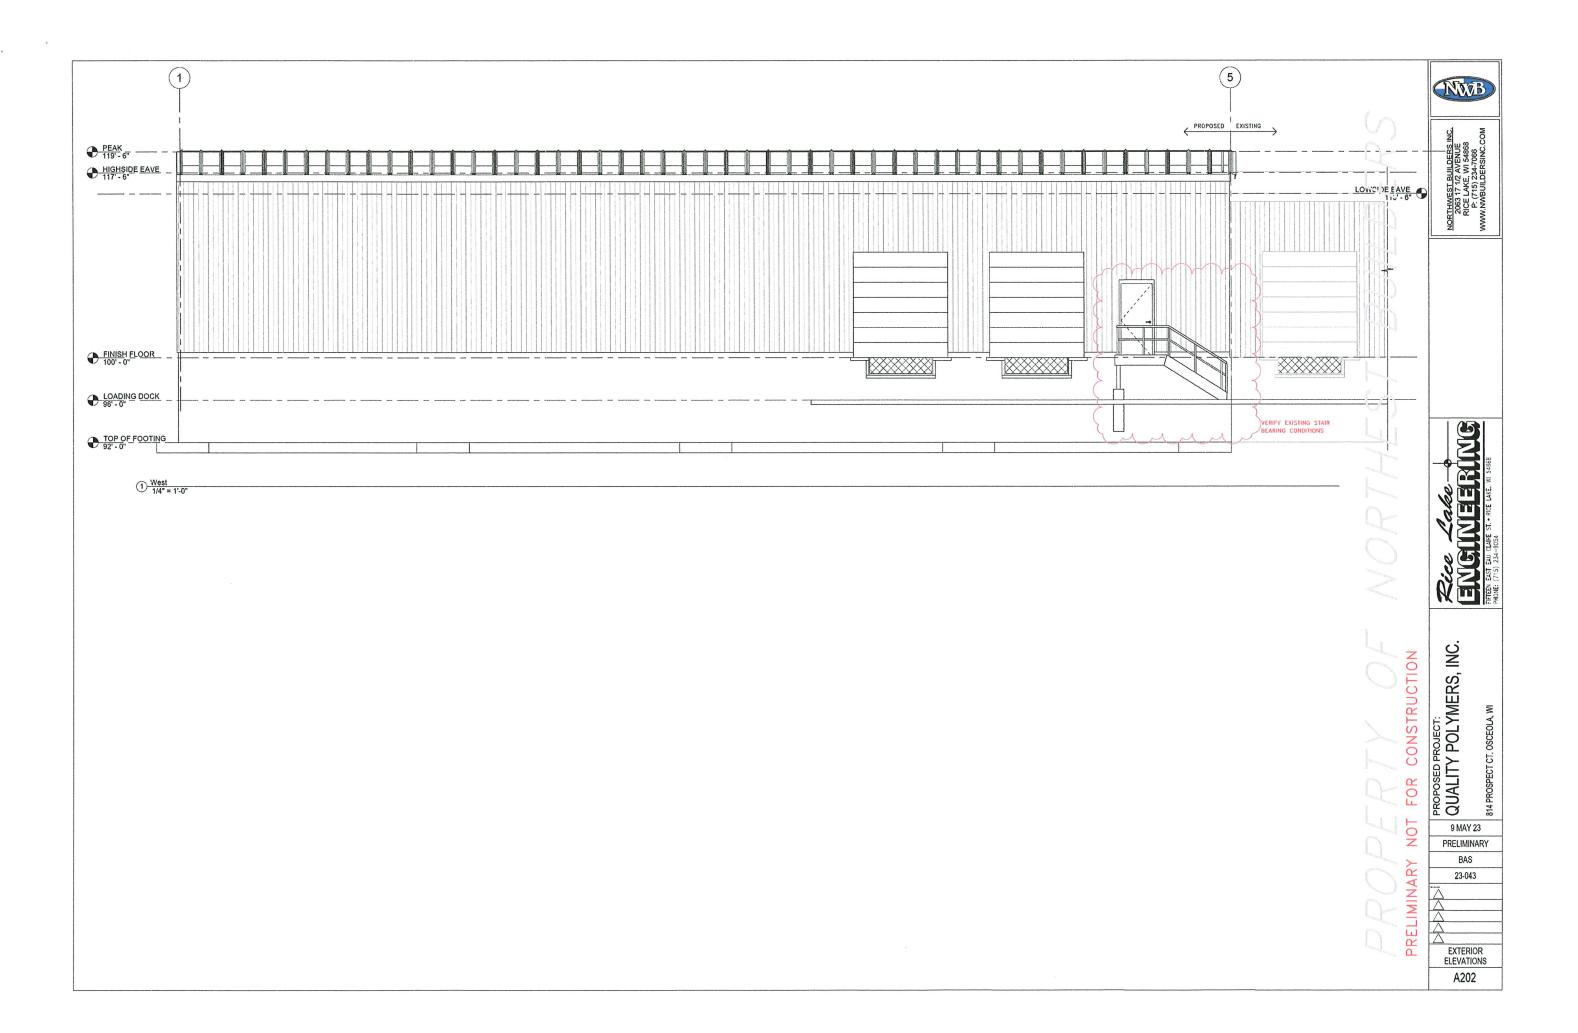

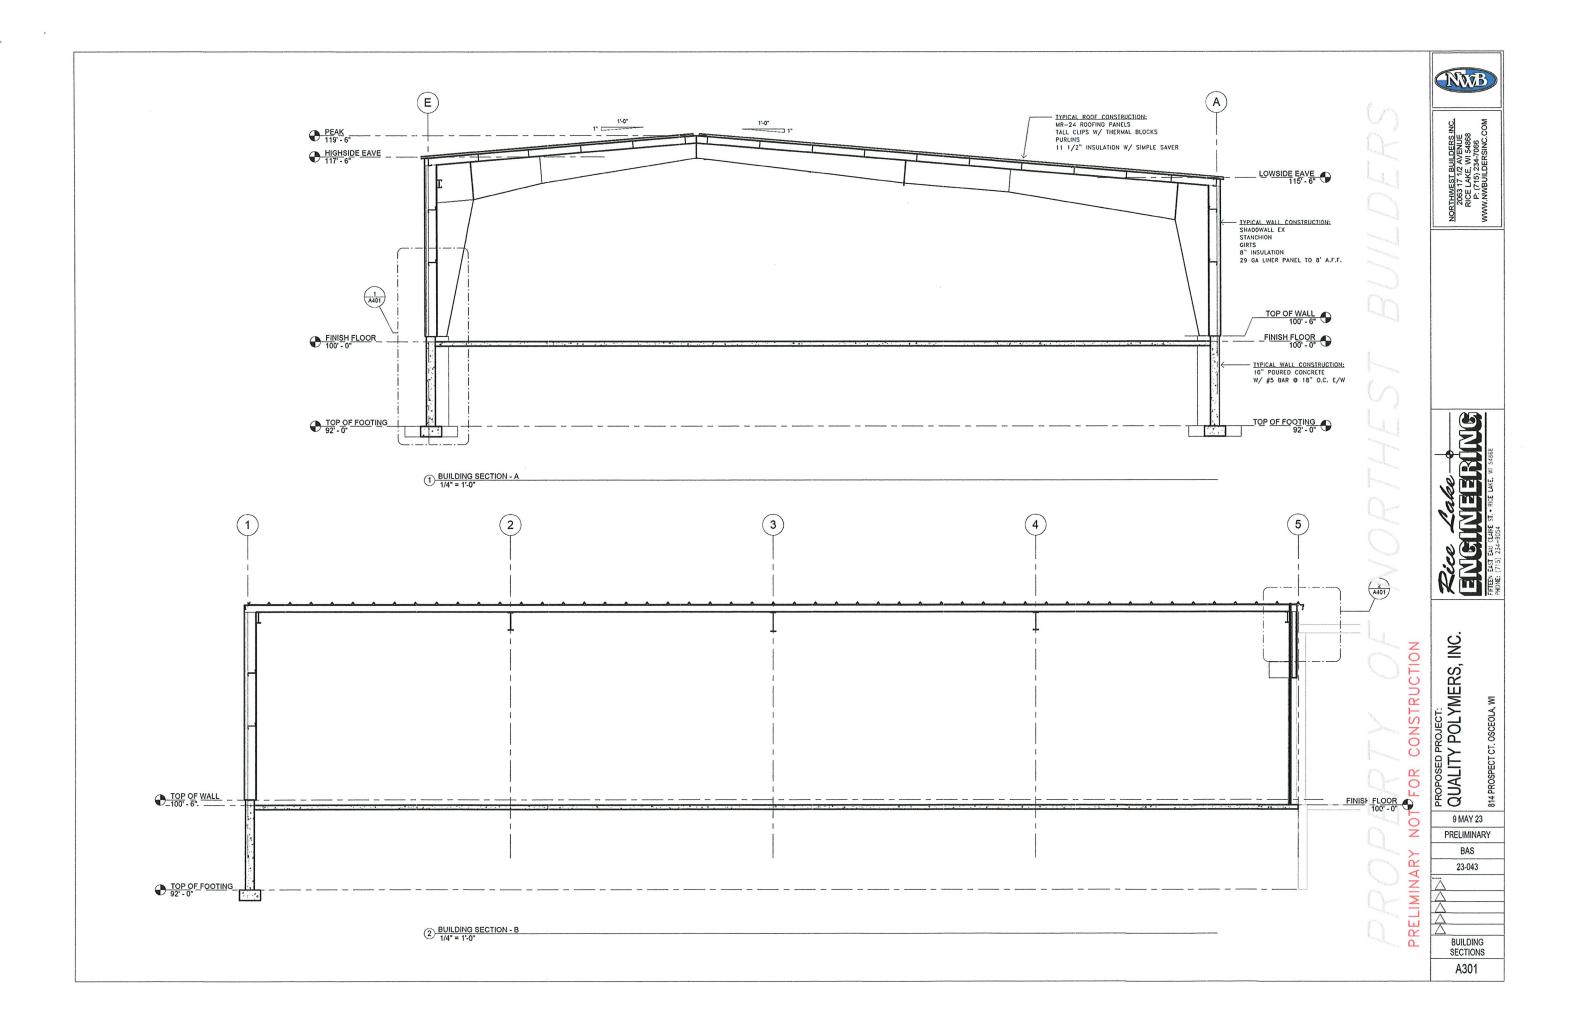

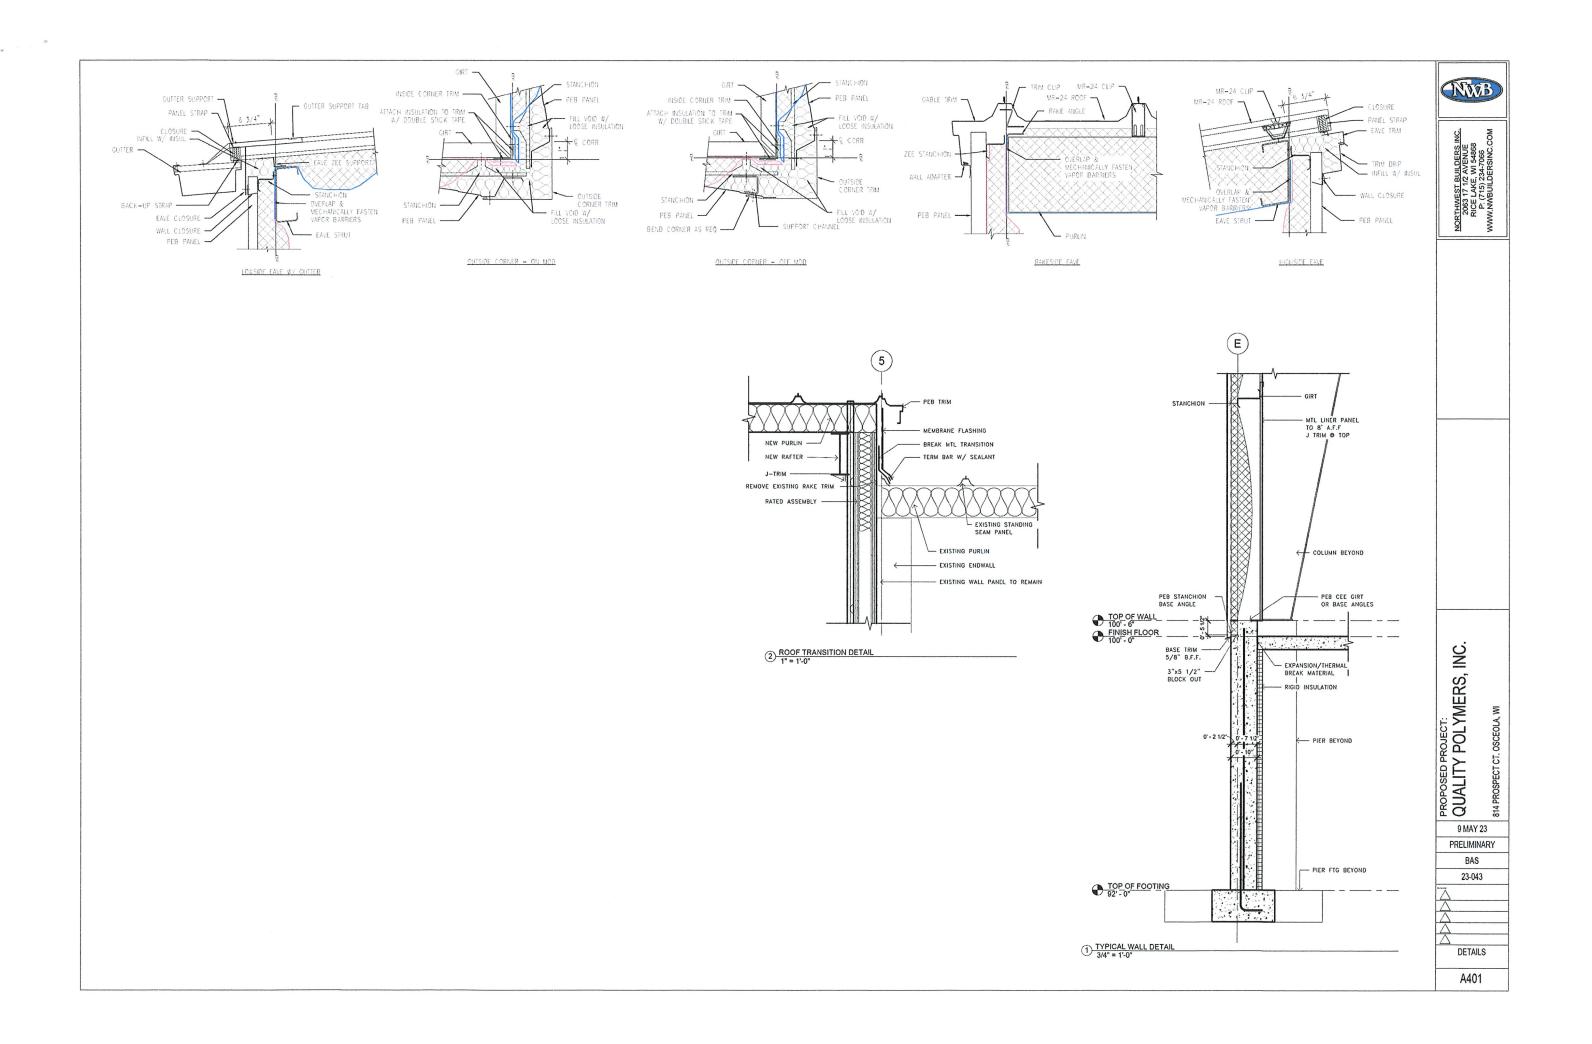






## OSCEOLA BLUFF APARTMENTS OSCEOLA VENTURES, LLC 301 RIVER STREET OSCEOLA, WI

## Know what's below. Call before you dig.

## PROJECT LOCATION

	CONTACTS						
VILLAGE ADMINISTRATOR	DEVIN SWANBERG 715.294.3498						
PUBLIC WORKS COORDINATOR	TODD WATERS 715.294.3407						
WATER	UTILITIES COORDINATOR - RICK CARUSO 715.294.2233						
SANITARY	UTILITIES COORDINATOR - RICK CARUSO 715.294.2233						
ELECTRIC	XCEL ENERGY POLK-BURNETT ELECTRIC COMPANY 800.895.4999 800.421.0283						
TELEPHONE	CENTURYLINK 800.201.4099						
CABLE	LAKELAND COMMUNICATIONS 715.825.2171						
GAS	WE ENGERGIES 800.242.9137						
FIRE DEPT.	FIRE CHIEF — PAUL ELFSTROM 715.294.3440						

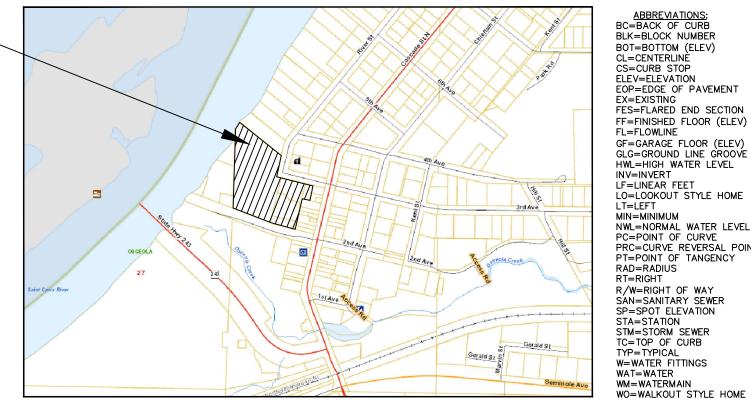

LOCATION MAP

SCHEDULE OF REQUIRED PERMITS							
APPROVALS NEEDED	DATE SUBMITTED	APPROVAL					
VILLAGE OF OSCEOLA SITE PLAN APPROVAL							
ST. CROIX RIVER DISTRICT							
WDNR: WRAPP							
DSPS: PLUMBING PLAN REVIEW							

## **LEGEND**

---BENCHMARK

**PROPOSED** 

**EXISTING** 

ABBREVIATIONS: BC=BACK OF CURB BLK=BLOCK NUMBER

BOT=BOTTOM (ELEV) CL=CENTERLINÈ CS=CURB STOP ELEV=ELEVATION EOP=EDGE OF PAVEMENT

FES=FLARED END SECTION FF=FINISHED FLOOR (ELEV)

LO=LOOKOUT STYLE HOME

NWL=NORMAL WATER LEVEL PC=POINT OF CURVE PRC=CURVE REVERSAL POINT PT=POINT OF TANGENCY

SP=SPOT ELEVATION STA=STATION STM=STORM SEWER TC=TOP OF CURB

W=WATER FITTINGS WM=WATERMAIN

WO=WALKOUT STYLE HOME

EX=EXISTING

FL=FLOWLINE

INV=INVFRT LF=LINEAR FEET

I T=I FFT MIN=MINIMUM

RT=RIGHT

TYP=TYPICAL

			CONTROL POINT
##	<del></del>	-	SIGN
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	<b>(</b>		WELL
	¥	<b>X</b>	HYDRANT
	¥		GATE VALVE
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●SAN CLEANOUT  □GAS MANHOLELIGHT POLEGUY WREGUY WREGUY POLE		ě	SAN MH
C		•	STORM MH
LIGHT POLE	<b>©</b>	•	SAN CLEANOUT
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ROW POST	Τ		TELE PED
REBAR	•		IRON PIPE
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	SHEET SCHEDULE				
SHEET NO.	DESCRIPTION				
1	TITLE SHEET				
2	EXISTING CONDITIONS & DEMOLITION PLAN				
3	SITE PLAN				
4	GRADING PLAN				
5	EROSION CONTROL PLAN				
6	UTILITY PLAN				
7-8	DETAILS				

AEC PROJECT #: 21136 PLANS DATED: APRIL 2023



ADVANCED ENGINEERING CONCEPTS 1360 INTERNATIONAL DR. EAU CLAIRE, WI 54701 PH 715-552-0330 INFO@AEC.ENGINEERING COPYRIGHT 2023, AEC LLC

56 EAST BROADWAY, SUITE 200 FOREST LAKE, MN 55025

EMAIL: danhebert@gaughancompanies.com

HARRISS ASSOCIATES, LLC 2836 44TH AVE SOUTH MINNEAPOLIS, MN 55406

PROJECT ENGINEER:
ADVANCED ENGINEERING CONCEPTS ATTN: SEAN BOHAN, P.E. 1360 INTERNATIONAL DRIVE EAU CLAIRE, WI 54701

PROJECT DEVELOPER/ CLIENT: OSCEOLA VENTURES, LLC ATTN: DAN HEBERT


PHONE: 651.255.5558

PROJECT ARCHITECT: ATTN: JOHN HARRISS AIA LEED-AP


PHONE: 612.940.6427 EMAIL: jharris@harrisarchitects.com


PHONE: 715.552.0330

EMAIL: sbohan@aec.engineering

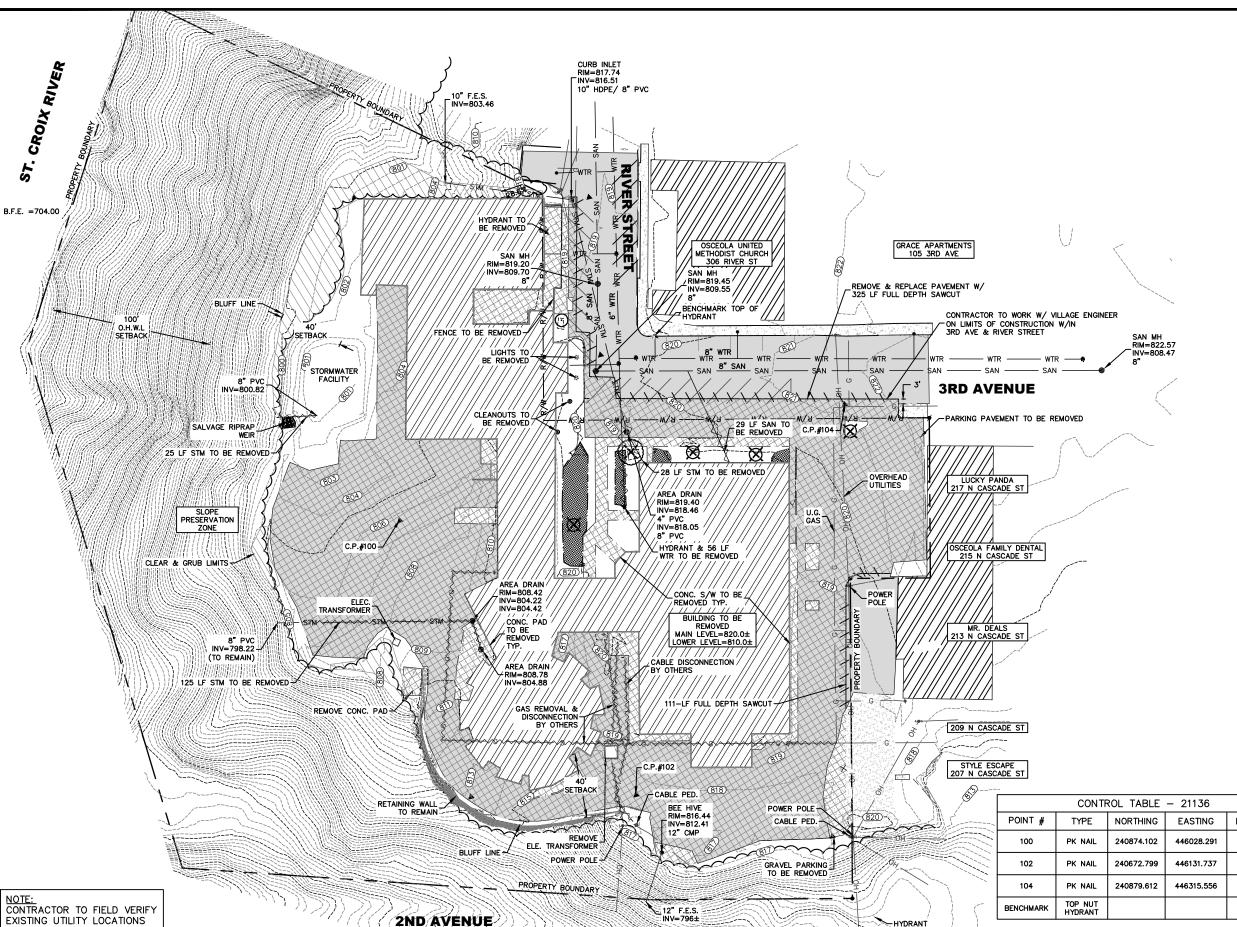



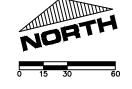

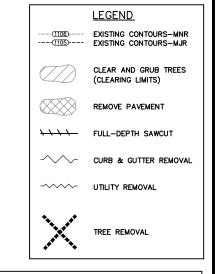

### GENERAL NOTES:

- . UNDERGROUND UTILITIES ARE SHOWN IN APPROXIMATE LOCATIONS ONLY AND ARE NOT SHOWN IN THEIR ENTIRETY. CONTRACTOR SHALL NOTIFY UTILITIES A MINIMUM OF 3 DAYS PRIOR TO ANY EXCAVATION FOR FIELD VERIFICATION OF LOCATIONS. THE CLIENT, CITY, AND THE ENGINEER ARE NOT RESPONSIBLE OR LIABLE FOR ANY DAMAGE CAUSED TO EXISTING UTILITIES.
- 2. CLEARING AND GRUBBING SHALL ONLY BE IN THOSE LOCATIONS DIRECTED BY THE ENGINEER AND/OR OWNER. CONTRACTOR SHALL PROTECT ALL TREES, SHRUBS, AND CORRESPONDING ROOT SYSTEMS FROM DAMAGE. ALL WORK WITH POTENTIAL IMPACT ON UN-CLEARED TREES AND/OR SHRUBS SHALL BE COORDINATED
- CONTRACTOR SHALL NOT DISTURB ANY R/W IRONS. ANY REMOVAL SHALL BE APPROVED BY THE ENGINEER, OTHERWISE THE CONTRACTOR SHALL BE BILLED FOR REPLACEMENT.
- CONTRACTOR SHALL VERIFY THE AMOUNT OF PAVEMENT REMOVAL WITH THE PROJECT MANAGER.
- 5. CONTRACTOR TO COORDINATE LOCATIONS AND LIMITS OF SAWCUTS WITH THE PROJECT MANAGER.
- NO TREES OR STUMPS ARE TO BE BURIED ON SITE. CONTRACTOR IS RESPONSIBLE FOR ANY PERMITS FOR BURNING OR MATERIAL DISPOSAL.
- 7. CONTRACTOR TO REPAIR AND RESTORE ANY DAMAGED OR DISTURBED AREAS OF PAVEMENT, CONCRETE, LANDSCAPING, ELECTRICAL, AND AUTOMATIC IRRIGATION, ETC. TO ITS ORIGINAL CONDITION ON ADJACENT PROPERTIES.
- 8. IF DURING THE COURSE OF CONSTRUCTION THE CONTRACTOR FINDS ANY DISCREPANCIES OR CONFLICTS BETWEEN THE PROPOSED SITE IMPROVEMENTS INDICATED ON THE PLANS AND THE PHYSICAL CONDITIONS OF THE SITE, OR ANY ERRORS OR OMISSIONS WITHIN THE PLANS OR IN THE SITE LAYOUT AS PROVIDED BY THE ENGINEER, IT SHALL BE THE RESPONSIBILITY OR THE CONTRACTOR TO IMMEDIATELY NOTIFY THE ENGINEER. UNTIL AUTHORIZED TO PROCEED, ANY WORK PERFORMED AFTER SUCH DISCOVERY WILL BE AT THE CONTRACTOR'S SOLE RISK AND EXPENSE.

CONTROL TABLE - 21136						
POINT #	POINT # TYPE NORTHING EASTING					
100	PK NAIL	240874.102	446028.291			
102	PK NAIL	240672.799	446131.737			
104	PK NAIL	240879.612	446315.556			
BENCHMARK	TOP NUT HYDRANT			822.82		

SURVEY NOTES:

1. TOPO SURVEY PERFORMED BY REAL LAND TOPO SURVEY PERFORMED BY REAL LAND SURVEYING MAY 12, 2021
UTILITY SIZES AND LOCATIONS ARE COMPILED FROM SURVEYS AND AS-BUILTS INFORMATION PROVIDED BY OTHERS. ADVANCED ENGINEERING CONCEPTS MAKES NO GUARANTEE AND IS NOT RESPONSIBLE FOR THE ACCURACY OF THE EXISTING LINEWORK. CONTRACTOR TO VERIFY EXISTING PRIVATE UTILITIES PRIOR TO ANY CONSTRUCTION TAKING PLACE.

PROJ. NO

21136

DESIGN BY CHECKED

NO. DATE

REVISIONS


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EXISTING CONDITIONS & DEMOLITION PLAN

OSCEOLA BLUFF APARTMENTS OSCEOLA VENTURES, LLC 301 RIVER STREET OSCEOLA, WI


DWG NAME 21136 PG2 EXISTING DATE 4/2023



DESIGN BY CHECKED

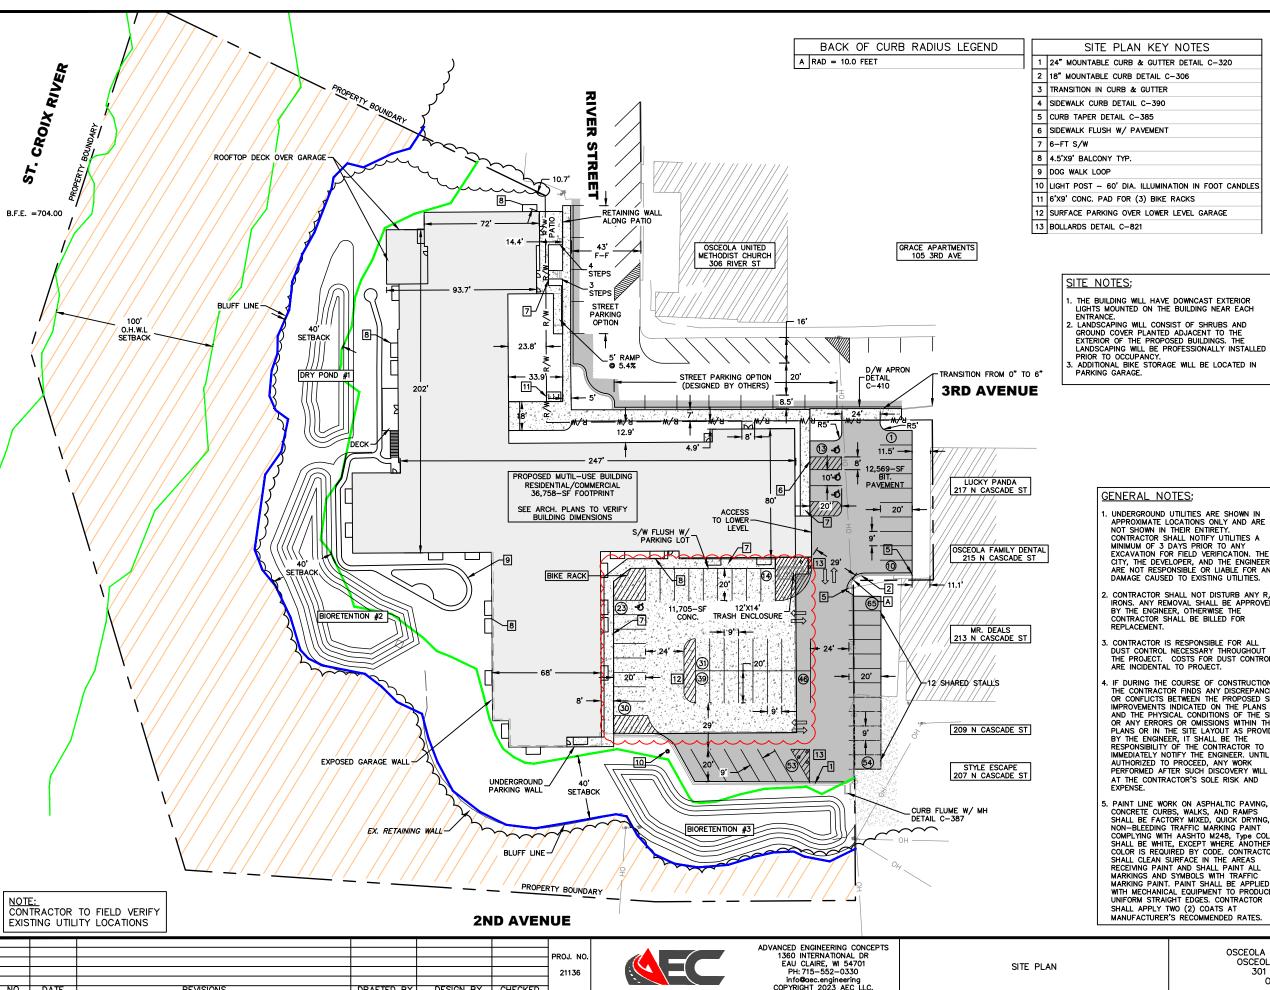REVISIONS

Know what's below. Call before you dig.

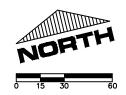

### OSCEOLA BLUFF APARTMENTS 301 RIVER STREET

EXISTING IMPERVIOUS AREA: 96.089-SF (47.8%)

CURRENT ZONING:

LOT SIZE:

200,685 SF (4.61 AC,)

PROPOSED USE:

MULTI-USE (99 RESIDENTIAL UNITS 2 COMMERCIAL UNITS)

PROPOSED BUILDING: PROPOSED PAVEMENT: PROPOSED PATIO/SIDEWALK: OVERALL IMPERVIOUSNESS: GREEN SPACE:

36,758-SF (18.3%) 24,614-SF (12.3%) 2,673-SF (1.3%) 64,045-SF (31.9%) 136,640-SF (68.1%)

PARKING STALLS:

109 GARAGE STALLS
3 GARAGE STALLS - ADA
61 SURFACE STALLS
4 SURFACE STALL - ADA 177 OVERALL PROVIDED (1.79:1)


BICYCLE STALLS: STORM WATER TREATMENT: 3 STALLS (EXTERIOR)

1 DRY POND & 2 BIORETENTION BASINS


SETBACKS FRONT: 0' SIDE: 0'

### **GENERAL NOTES:**

- UNDERGROUND UTILITIES ARE SHOWN IN APPROXIMATE LOCATIONS ONLY AND ARE NOT SHOWN IN THEIR ENTIRETY.
  CONTRACTOR SHALL NOTIFY UTILITIES A
  MINIMUM OF 3 DAYS PRIOR TO ANY
  EXCAVATION FOR FIELD VERIFICATION. THE CITY, THE DEVELOPER, AND THE ENGINEER ARE NOT RESPONSIBLE OR LIABLE FOR ANY DAMAGE CAUSED TO EXISTING UTILITIES.
- . CONTRACTOR SHALL NOT DISTURB ANY R/W IRONS. ANY REMOVAL SHALL BE APPROVED BY THE ENGINEER, OTHERWISE THE CONTRACTOR SHALL BE BILLED FOR REPLACEMENT.
- CONTRACTOR IS RESPONSIBLE FOR ALL DUST CONTROL NECESSARY THROUGHOUT THE PROJECT. COSTS FOR DUST CONTROL ARE INCIDENTAL TO PROJECT.
- . IF DURING THE COURSE OF CONSTRUCTION THE CONTRACTOR FINDS ANY DISCREPANCIES OR CONFLICTS BETWEEN THE PROPOSED SITE IMPROVEMENTS INDICATED ON THE POSED AND THE PHYSICAL CONDITIONS OF THE SITE, OR ANY ERRORS OR OMISSIONS WITHIN THE PLANS OR IN THE SITE LAYOUT AS PROVIDED BY THE ENGINEER, IT SHALL BE THE RESPONSIBILITY OF THE CONTRACTOR TO IMMEDIATELY NOTIFY THE ENGINEER. UNTIL AUTHORIZED TO PROCEED, ANY WORK
  PERFORMED AFTER SUCH DISCOVERY WILL BE AT THE CONTRACTOR'S SOLE RISK AND
- 5. PAINT LINE WORK ON ASPHALTIC PAVING, CONCRETE CURBS, WALKS, AND RAMPS SHALL BE FACTORY MIXED, QUICK DRYING, NON-BLEEDING TRAFFIC MARKING PAINT COMPLYING WITH AASHTO M248, Type COLOR SHALL BE WHITE, EXCEPT WHERE ANOTHER COLOR IS REQUIRED BY CODE. CONTRACTOR SHALL CLEAN SURFACE IN THE AREAS RECEIVING PAINT AND SHALL PAINT ALL MARKINGS AND SYMBOLS WITH TRAFFIC MARKING PAINT. PAINT SHALL BE APPLIED WITH MECHANICAL EQUIPMENT TO PRODUCE UNIFORM STRAIGHT EDGES. CONTRACTOR SHALL APPLY TWO (2) COATS AT MANUFACTURER'S RECOMMENDED RATES.

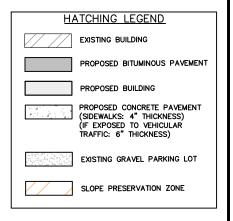



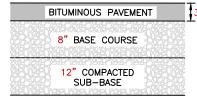

NOTE: PAVEMENT SECTIONS TO BE CONSTRUCTED PER GEOTECHNICAL ENGINEERING REPORT. PAVEMENT SECTIONS ABOVE SHALL BE USED FOR ASSUMED HOLD—DOWN CALCULATIONS ONLY.

OSCEOLA BLUFF APARTMENTS OSCEOLA VENTURES, LLC 301 RIVER STREET OSCEOLA, WI

DWG NAME 21136 PG3 SITE DATE 4/2023





**GRADING PLAN LEGEND** 

DRAINAGE PATTERN LINES

- GRADE BREAK LINES PROPOSED DRAINAGE DIRECTION + XXX.XX PROPOSED SPOT ELEVATION

BW GROUND AT TOE OF WALL

ALL CONTOURS ARE COMPUTER GENERATED AND REPRESENT APPROXIMATE LOCATIONS. PROPOSED CONTOURS REPRESENT FINISHED GROUND GRADES AFTER RESTORATION. CONTOURS IN STREET REPRESENT THE TOP OF PAVEMENT.

CONTRACTOR SHALL BE RESPONSIBLE FOR INSURING POSITIVE DRAINAGE AWAY FROM STRUCTURES. BUILDER SHALL VERIFY ACTUAL

FINISH FLOOR ELEVATION(S) PRIOR TO CONSTRUCTION AND SHALL INSURE ALL SITE DRAINAGE IS DIRECTED AWAY FROM STRUCTURES AND TOWARD DRAINAGE WAYS.

ALL SPOT ELEVATIONS ARE TOP OF PAVEMENT AND/OR FINISHED GRADE UNLESS OTHERWISE NOTED.

OVER EXCAVATE THE BIORETENTION FILTER TO VIRGIN MATERIAL AND DEEP-TILL THE IN-SITU SOIL. PLACE CLEAN GRANULAR SAND AND CONSTRUCT REMAINING BED PER DETAIL C-900. PLACE EROSION MAT IMMEDIATELY AFTER

GRADING. EROSION MAT TO REMAIN IN-PLACE UNTIL THE TIME THAT THE B.R.F. IS PROFESSIONALLY LANDSCAPED AND PLANTED.

REPLACE MAT WITH LANDSCAPE MULCH OR NEW EROSION MAT.

5. IF DURING THE COURSE OF CONSTRUCTION THE CONTRACTOR FINDS ANY DISCREPANCIES OR CONFLICTS BETWEEN THE PROPOSED SITE IMPROVEMENTS INDICATED ON THE PLANS AND THE PHYSICAL CONDITIONS OF THE SITE, OR ANY ERRORS OR OMISSIONS WITHIN THE PLANS OR IN THE SITE LAYOUT AS PROVIDED BY THE ENGINEER, IT SHALL BE THE RESPONSIBILITY OF THE CONTRACTOR TO IMMEDIATELY NOTIFY THE ENGINEER. UNTIL AUTHORIZED TO PROCEED, ANY WORK PERFORMED AFTER SUCH DISCOVERY WILL BE ALT THE CONTRACTOR'S SOLE RISK AND

BE AT THE CONTRACTOR'S SOLE RISK AND EXPENSE.

+ xxx.x $\pm$  existing spot elevation FF FINISHED FLOOR ELEVATION


> TC TOP OF CURB TP TOP OF PAVEMENT TW TOP OF WALL ELEVATION

GRADING NOTES:

-(1106)----- EXISTING CONTOURS-MNR

-- 1105---- EXISTING CONTOUR-MJR

-849------FINAL CONTOUR-MNR

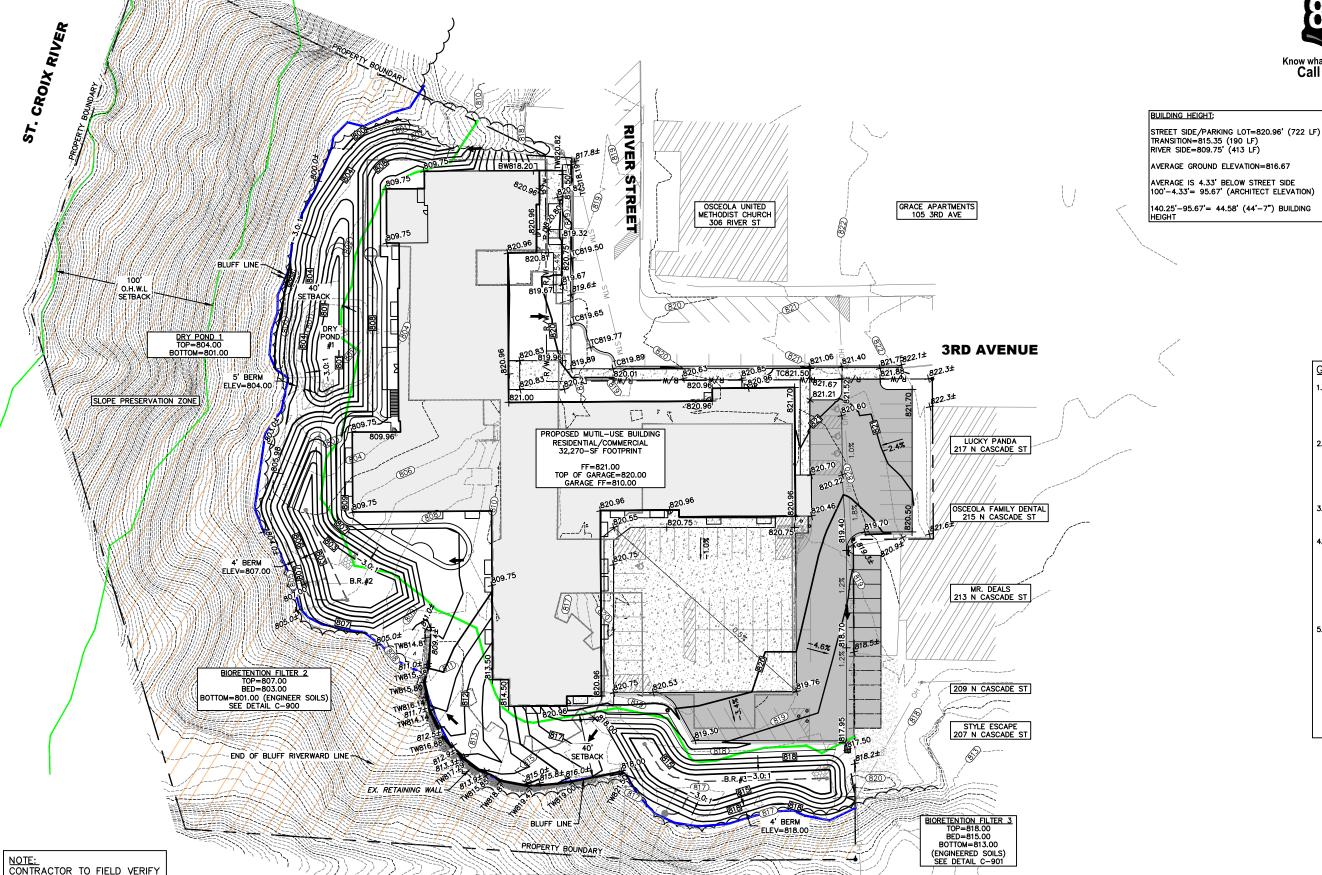

**2ND AVENUE** 

DESIGN BY CHECKED

DRAFTED BY

PROJ. NO

21136

EXISTING UTILITY LOCATIONS


NO. DATE

REVISIONS

OSCEOLA BLUFF APARTMENTS
OSCEOLA VENTURES, LLC
301 RIVER STREET
OSCEOLA WI


ADVANCED ENGINEERING CONCEPTS 1360 INTERNATIONAL DR EAU CLAIRE, WI 54701 PH: 715-552-0330

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THE EROSION CONTROL ON THIS PLAN HAS BEEN PREPARED AS A GUIDE. THE CONTRACTOR SHALL BE RESPONSIBLE FOR MAINTAINING, MODIFYING AND IMPLEMENTING AN ALTERNATE EROSION CONTROL PLAN BASED ON THEIR MEANS, METHODS, TECHNIQUES, SEQUENCES, AND PROCEDURES OF CONSTRUCTION.

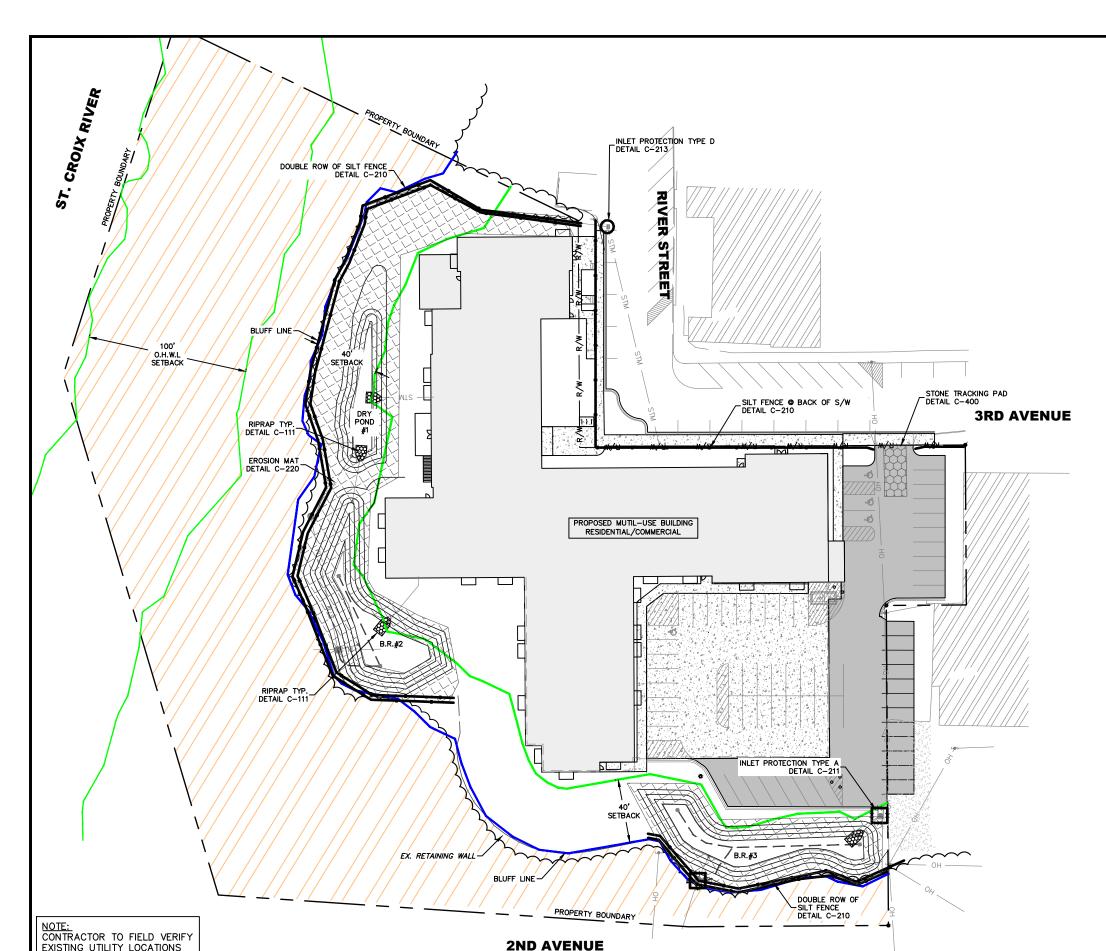EROSION CONTROL NOTES:

1. POST WONR CERTIFICATE OF PERMIT COVERAGE ON SITE AND MAINTAIN UNTIL CONSTRUCTION ACTIVITIES HAVE CEASED, THE SITE IS STABILIZED, AND A NOTICE OF TERMINATION IS FILED WITH WONR.

2. KEEP A COPY OF THE CURRENT EROSION CONTROL PLAN ON SITE THROUGHOUT THE DURATION OF THE PROJECT.

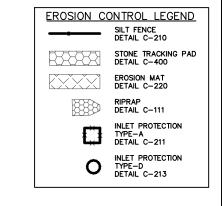3. SUBMIT PLAN REVISIONS OR AMERIDMENTS TO THE WORN AT LEAST 5 DAYS PRIOR TO FIELD IMPLEMENTATION.

4. GENERAL CONTRACTOR IS RESPONSIBLE FOR ROUTINE SITE INSPECTIONS AT LEAST ONCE EVERY 7 DAYS AND WITHIN 24

HOURS AFTER A RAINFALL EVENT OF 0.5 INCHES OR GREATER. KEEP INSPECTION REPORTS ON-SITE AND MAKE THEM

HOURS AFTER A RAINFALL EVENT OF 0.5 INCHES OR GREATER. KEEP INSPECTION REPORTS ON—SITE AND MAKE THEM AVAILABLE UPON REQUEST.
INSPECT AND MAINTAIN ALL INSTALLED EROSION CONTROL PRACTICES UNTIL THE CONTRIBUTING DRAINAGE AREA HAS BEEN STABILIZED.

WHEN POSSIBLE: PRESERVE EXISTING VEGETATION (ESPECIALLY ADJACENT TO SURFACE WATERS), MINIMIZE LAND-DISTURBING CONSTRUCTION ACTIVITY ON SLOPES OF 20% OR MORE, MINIMIZE SOIL COMPACTION, AND PRESERVE TOPSOIL.

REFER TO THE WDNR STORMWATER CONSTRUCTION TECHNICAL STANDARDS AT

REFER TO THE WDNR STORMWATER CONSTRUCTION TECHNICAL STANDARDS AT http://dnr.wi.gov/topic/stormwater/standards/const\_standards.html.

INSTALL PERIMETER EROSION CONTROLS AND STONE TRACKING PAD CONSTRUCTION ENTRANCE(S) PRIOR TO ANY LAND-DISTURBING ACTIVITIES, INCLUDING CLEARING AND GRUBBING. USE WONR TECHNICAL STANDARD STONE TRACKING PAD AND TIRE WASHING #1057 FOR ROCK CONSTRUCTION ENTRANCE(S).

INSTALL INLET PROTECTION PRIOR TO LAND-DISTURBING ACTIVITIES IN THE CONTRIBUTING DRAINAGE AREA AND/OR IMMEDIATELY UPON INLET INSTALLATION. COMPLY WITH WONR TECHNICAL STANDARD STOMM DRAIN INLET PROTECTION FOR CONSTRUCTION SITES #1060.

STAGE CONSTRUCTION GRADING ACTIVITIES TO MINIMIZE THE CUMULATIVE EXPOSED AREA. CONDUCT TEMPORARY GRADING FOR EROSION CONTROL #1067.

COMPLETE AND STABILIZE SEDIMENT BASINS/TRAPS OR WET POINTS BRIOR TO MASS LAND DISTURBATION TO CONTROL.

CONFIDETE AND STABILIZE SEDIMENT BASINS/TRAPS OR WET PONDS PRIOR TO MASS LAND DISTURBANCE TO CONTROL RUNOFF DURING CONSTRUCTION. REMOVE SEDIMENT AS NEEDED TO MAINTAIN 3 FEET OF DEPTH TO THE OUTLET, AND

RUNOFF DURING CONSTRUCTION. REMOVE SEDIMENT AS NEEDED TO MAINTAIN 3 FEET OF DEPTH TO THE OUTLET, AND PROPERLY DISPOSE OF SEDIMENT REMOVED DURING MAINTENANCE (REFER TO NES28). CONSTRUCT AND MAINTAIN THE SEDIMENT BASIN PER WONR TECHNICAL STANDARD SEDIMENT BASIN #1064 AND SEDIMENT TRAP #1063.

12. CONSTRUCT AND PROTECT THE BIORETENTION FILER AND VEGETATION FROM RUNOFF AND SEDIMENT DURING CONSTRUCTION. REFERENCE THE WONR TECHNICAL STANDARD BIORETENTION FOR #1004.

13. INSTALL AND MAINTAIN SLIT FENCING PER WONR TECHNICAL STANDARD SLIT FENCE #1056. REMOVE SEDIMENT FROM BEHIND SILT FENCES AND SEDIMENT BARRIERS BEFORE SEDIMENT REACHES A DEPTH THAT IS EQUAL TO ONE—HALF OF

THE FENCE AND/OR BARRIER HEIGHT.

REPAIR BREAKS AND GAPS IN SILT FENCES AND BARRIERS IMMEDIATELY. REPLACE DECOMPOSING STRAW BALES

(TYPICAL BALE LIFE IS 3 MONTHS). LOCATE, INSTALL, AND MAINTAIN STRAW BALES PER WONR TECHNICAL STANDARD

(TYPICAL BALE LIFE IS 3 MONTHS). LOCATE, INSTALL, AND MAINTAIN STRAW BALES PER WONR TECHNICAL STANDARD DITCH CHECKS #1062.

15. IMMEDIATELY STABILIZE STOCKPILES AND SURROUND STOCKPILES AS NEEDED WITH SILT FENCE OR OTHER PERIMETER CONTROL IF STOCKPILES WILL REMAIN INACTIVE FOR 7 DAYS OR LONGER.

16. IMMEDIATELY STABILIZE ALL DISTURBED AREAS THAT WILL REMAIN INACTIVE FOR 14 DAYS OR LONGER. BETWEEN SEPTEMBER 15 AND COTOBER 15: STABILIZE WITH MULCH, TACKIFIER, AND A PERENNIAL SEED MIXED WITH WINTER WHEAT, ANNUAL OATS, OR ANNUAL RYE, AS APPROPRIATE FOR REGION AND SOIL TYPE OCTOBER 15 THROUGH COLD WEATHER: STABILIZE WITH A POLYMER AND DORMANT SEED MIX, AS APPROPRIATE FOR REGION AND SOIL TYPE.

17. STABILIZE AREAS OF FINAL GRADING WITHIN 7 DAYS OF REACHING FINAL GRADE FINAL GRADE STABLES AND ASSESSMENT OF THE STABLES OF THE STABLE

BEFORE THE END OF THE SAME WORKDAY, SEPARATE SWEPT MATERIALS (SOILS AND TRASH) AND DISPOSE OF

APPROPRIATELY.

19. CONTRACTOR IS RESPONSIBLE FOR CONTROLLING DUST PER WDNR TECHNICAL STANDARD DUST CONTROL ON CONSTRUCTION SITES #1068.

19. CONTRUCTION IS RESPAISBLE FOR CONTROCLING DOST FER WORK TECHNICAL STANDARD BOST CONTROL ON CONSTRUCTION STIES #1088.

20. PROPERLY DISPOSE OF ALL WASTE AND UNUSED BUILDING MATERIALS (INCLUDING GARBAGE, DEBRIS, CLEANING WASTES, OR OTHER CONSTRUCTION MATERIALS) AND DO NOT ALLOW THESE MATERIALS TO BE CARRIED BY RUNOFF INTO THE RECEIVING CHANNEL.

21. COORDINATE WITH ENGINEER TO UPDATE THE LAND DISTURBANCE PERMIT TO INDICATE THE ANTICIPATED OR LIKELY DISPOSAL. LOCATIONS FOR ANY EXCAVATED SOILS OR CONSTRUCTION DEBRIS THAT MILL BE HAULED OFF—SITE FOR DISPOSAL. THE DEPOSITED OR STOCKPILED MATERIAL NEEDS TO INCLUDE PERIMETER SEDIMENT CONTROL MEASURES (SUCH AS SILT FENCE, HAY BALES, FILTER SOCKS, OR COMPACTED EARTHEN BERMS).

22. FOR NON-CHANNELIZED FLOW ON DISTURBED OR CONSTRUCTED SLOPES, PROVIDE CLASS I TYPE A EROSION CONTROL MATTING. SELECT EROSION MATTING FROM APPROPRIATE MATRIX IN WOOTS WIDDOT PRODUCT ACCEPTABILITY LIST (PAL); INSTALL AND MAINTAIN PER WONR TECHNICAL STANDARD NON-CHANNEL EROSION MAT #1052.

23. FOR CHANNELIZED FLOW ON DISTURBED OR CONSTRUCTED AREAS, PROVIDE CLASS II TYPE B EROSION CONTROL MATTING, SELECT EROSION MATTING FROM APPROPRIATE MATRIX IN WOOTS WIDDT PRODUCT ACCEPTABILITY LIST (PAL); INSTALL AND MAINTAIN PER WONR TECHNICAL STANDARD NON-CHANNEL EROSION MAT #1052.

24. MAKE PROVISIONS FOR WATERING DURING THE FIRST 8 WEEKS FOLLOWING SEEDING OR PLANTING OF DISTURBED AREAS WHENEVER MORE THAN 7 CONSECUTIVE DAYS OF DRY WEATHER OCCUR.

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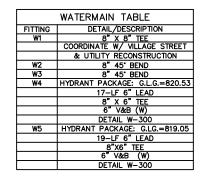
EXISTING UTILITY LOCATIONS




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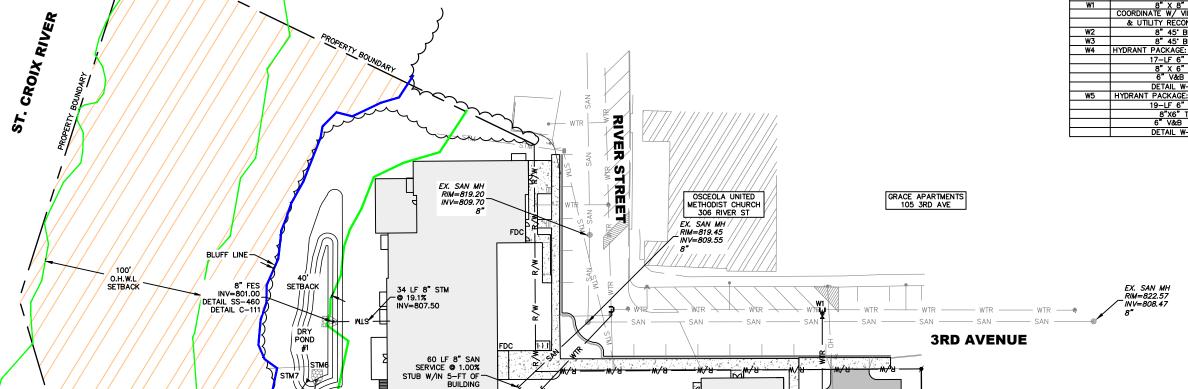
EROSION CONTROL PLAN 301 RIVER STREET OSCEOLA, WI

DWG NAME OSCEOLA BLUFF APARTMENTS OSCEOLA VENTURES, LLC 21136 PG5 EROSION







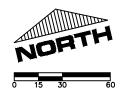

PROPOSED MUTIL-USE BUILDING

RESIDENTIAL/COMMERCIAL FF=821.00 GF=810.00

SETBACK

EX. BEE HIVE INSTALL STOOL CASTING

NEW INV=814.75 (12") NEW INV=812.50 (6" DT) EX INV=812.4± (12" CMP)

**2ND AVENUE** 

NEW RIM=818 00

PROPERTY BOUNDARY

STORM SEWER TABLE					
STRUCTURE NO.	DETAIL NO.	RIM	INVERT	DIRECTION	PIPE DIA.
STM1	SS-226	817.50	815.10	SW	12" RCP
STM2	SS-400	-	815.00	NE	12" RCP
	C-111				
STM3	SS-460		815.00	s	12" STM
STM4	SS-460	-	803.00	-	8" STM
	C-111				
STM5	SS-460	-	804.90	-	4" STM
STM6	SS-460	-	801.00	-	4" STM
	C-111				
STM7	SS-460	-	801.00	-	4" STM
STM8	SS-226	803.50	800.68	NE	4" STM
			800.68	s	8" STM
STM9	SS-226	806.35	803.00	E	4" STM
			800.50	E	6" DT
			800.10	N	8" STM
			799.70	W	8" STM-EX
STM10	SS-460		803.00		4" STM

### UTILITY NOTES:

- STORM AND SANITARY PIPE LENGTHS ARE TO CENTER OF MANHOLE. CONTRACTOR TO VERIFY ACTUAL LENGTH REQUIRED.

  MANHOLES ARE 48"Ø UNLESS OTHERWISE NOTED.

  ALL LENGTHS OF PIPE INCLUDE FLARED END SECTION (F.E.S.). CONTRACTOR WILL ONLY BE PAID FOR L.F. OF PIPE, NOT INCLUDING LENGTH OF F.E.S.

  MAINTAIN A MINIMUM 7.5' WATERMAIN COVER. ALL WATERMAIN MUST BE INSTALLED ACCORDING TO VILLAGE OF OSCEOLA. REFER TO STANDARD DETAILS FOR ALL UTILITY INSTALLATION. CONTACT CITY INSPECTOR AT LEAST 72 HOURS PRIOR TO START OF UTILITY CONSTRUCTION SO THAT INSPECTION CAN BE SCHEDULED.

  12" CLEARANCE WHEN WATERMAIN GOES OVER SANITARY, WATERMAIN, OR STORM SEWER & 18" SEPARATION WHEN WATERMAIN PASSES UNDER SANITARY, WATERMAIN OR STORM SEWER & 18" UPON COMPLETION OF STORM SEWER INSTALLATION, STORM SEWER INLETS SHALL BE PROTECTED FROM SEDIMENT BY SILT FENCE, HAY BALES, OR EQUIVALENT MEASURES. PROTECTION SHALL REMAIN IN PLACE UNTIL ASPHALT AREAS HAVE BEEN PAVED AND ALL NONE PAVED AREAS HAVE 100% VEGETATION ESTABLISHED.
- CONTRACTOR MUST PROTECT THE SANITARY LATERAL FROM ANY SAND, ROCK, ECT. ENTERING THE PIPE DURING CONSTRUCTION.
- SANITARY SEWER LATERALS SHALL HAVE MINIMUM SLOPE OF 1" PER FOOT FOR ALL 8-INCH PIPE (1000

- OFU S).

  CONTRACTOR SHALL VERIFY THE TOTAL DRAINAGE FIXTURE UNITS (DFU's) AND PIPE SIZES WITH THE PLUMBING PLANS.

  SANITARY SEWER SERVICE SHALL BE PVC (SDR 35).

  WATER SERVICE SHALL BE 6° D.I.P. OR APPROVED EQUAL.

  STORM SEWER SHALL BE ADS N-12 WT IB PIPE OR PRINSCO GOLDFLO WT OR SDR35 PVC OR APPROVED FOLIA!
- 12. THE PIPE DIAMETER'S LISTED ARE THE NOMINAL INSIDE DIAMETER.
  13. HYDRANT PACKAGE INCLUDES 6" VALVE & BOX

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PROPERTY BOUNDARY

30 LF

4"STM

B.R.#2

@ 13.0%

63 LF 6" WTR SERVICE STUB W/IN-5-FT OF BUILDING

38 LF 8" STM -@ 11.8% INV=807.50

EX. RETAINING WALL

BLUFF LINE -

46 LF 4" STM @ 0.70%

85 LF 8" STM @ 0.68%

CONTRACTOR TO FIELD VERIFY

EXISTING UTILITY LOCATIONS

EX. 8" PVC

14 LF 4" STM @ 0.0%-



\_EX. 12" F.E.S. INV=796±

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RCP @ 0.50%

8" 45" BEND-

5 122

BOLLARDS DETAIL C-821

BOLLARDS

UTILITY PLAN

LUCKY PANDA 217 N CASCADE ST

OSCEOLA FAMILY DENTAL 215 N CASCADE ST

MR. DEALS 213 N CASCADE ST

209 N CASCADE ST

STYLE ESCAPE 207 N CASCADE ST

- CONNECT TO EX. WATERMAIN ON 2ND AVE

B" D.I. W.M.


8" D.I. W.M.


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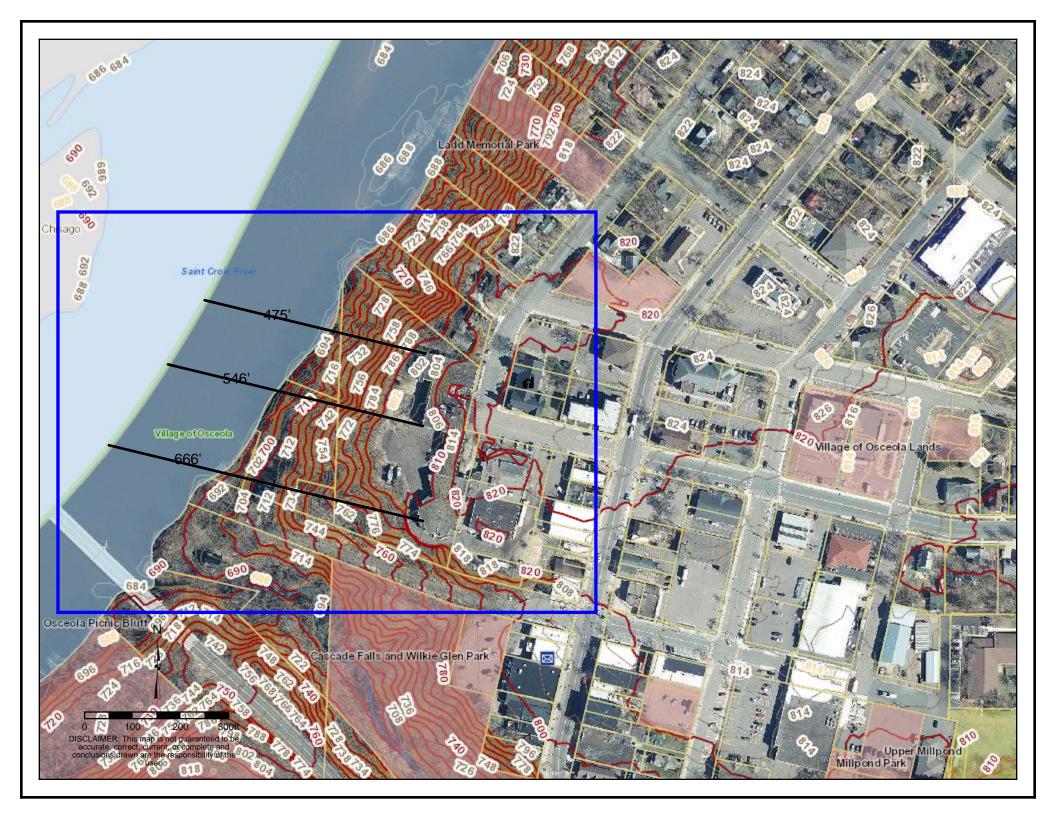
EX. HYDRANT

OSCEOLA BLUFF APARTMENTS OSCEOLA VENTURES, LLC 301 RIVER STREET OSCEOLA, WI

DWG NAME 21136 PG6 UTILITY DATE 4/2023



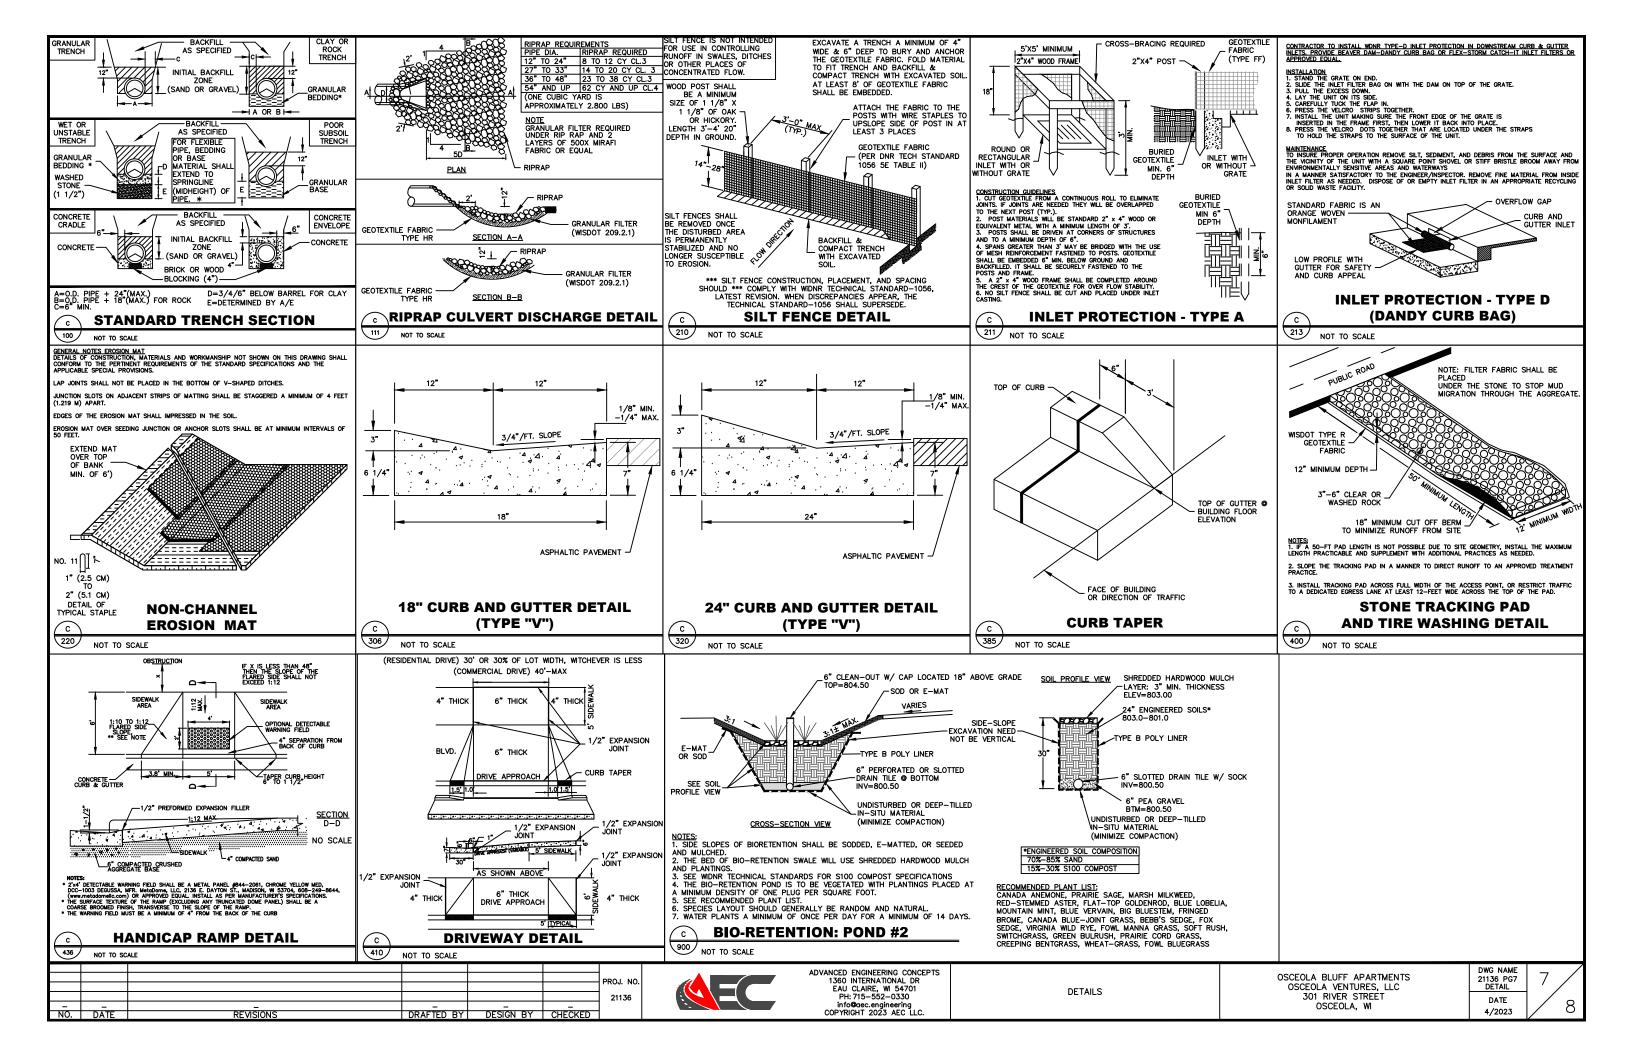


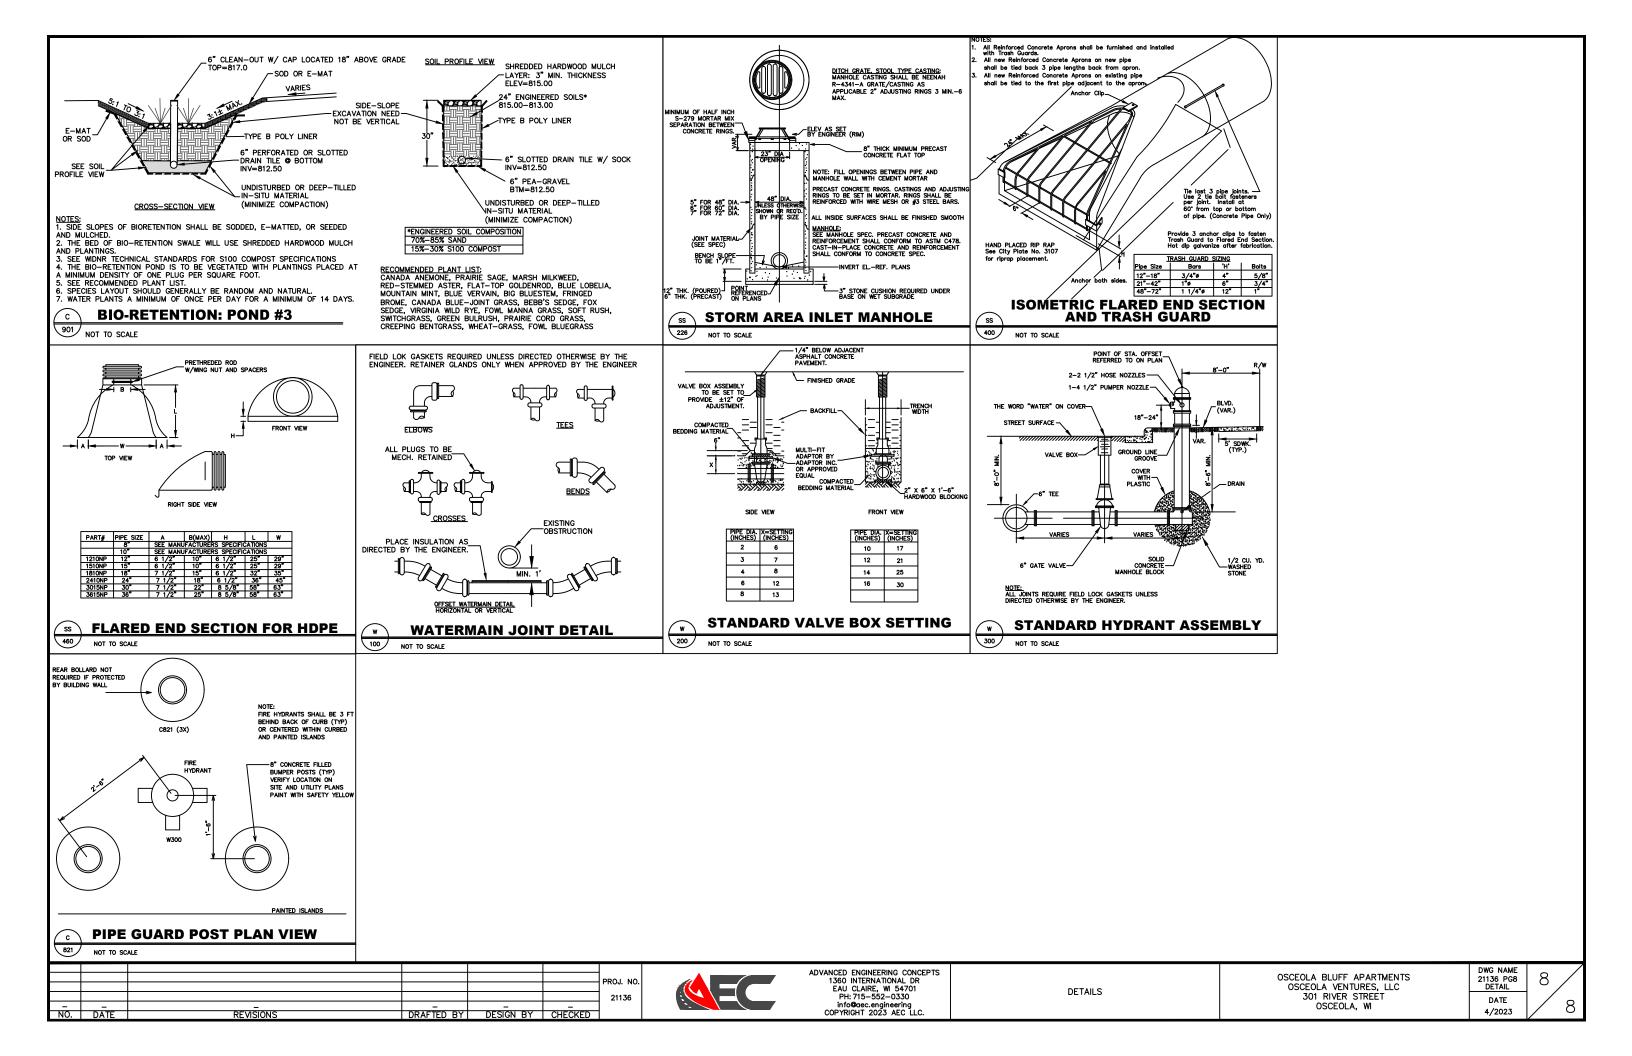



ARCHITECTURAL SITE PLAN

1" = 30'-0"

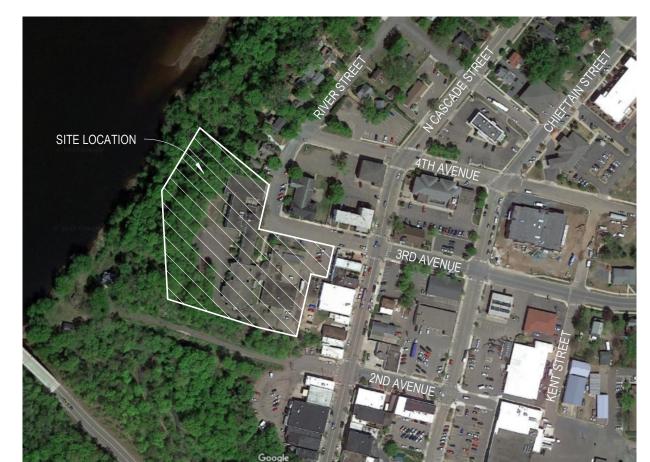

SITE CONTEXT

1" = 300'-0"

PARKING COUNT					
ACCESSIBLE - LL	3				
STANDARD - LL	109				
ACCESSIBLE	4				
STANDARD	61				
TOTAL PARKING	177				

UNIT COUNT BY TYPE		
UNIT TYPE	COUNT	
1 BED	50	
1 BED +	26	
2 BED	20	
ALCOVE	3	
GRAND TOTAL: 99	-	

## OSCEOLA BLUFFS **APARTMENTS**

# **GAUGHAN**

OWNER:
Gaughan Companies
Dan Hebert, Vice President
56 East Broadway Avenue
Forest Lake, MN 55025
(651) 255-5558
danhebert@gaughancompanies.com

CIVIL ENGINEER:
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John Harriss, Owner
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ARCHITECT OF RECORD:
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Brian Gadient, Partner
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St. Paul, MN 55104
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brian@mdgarchitects.com

Architecture




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As indicated



OSCEOLA BLUFFS **APARTMENTS** 

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(651) 255-5558 danhebert@gaughancompanies.com

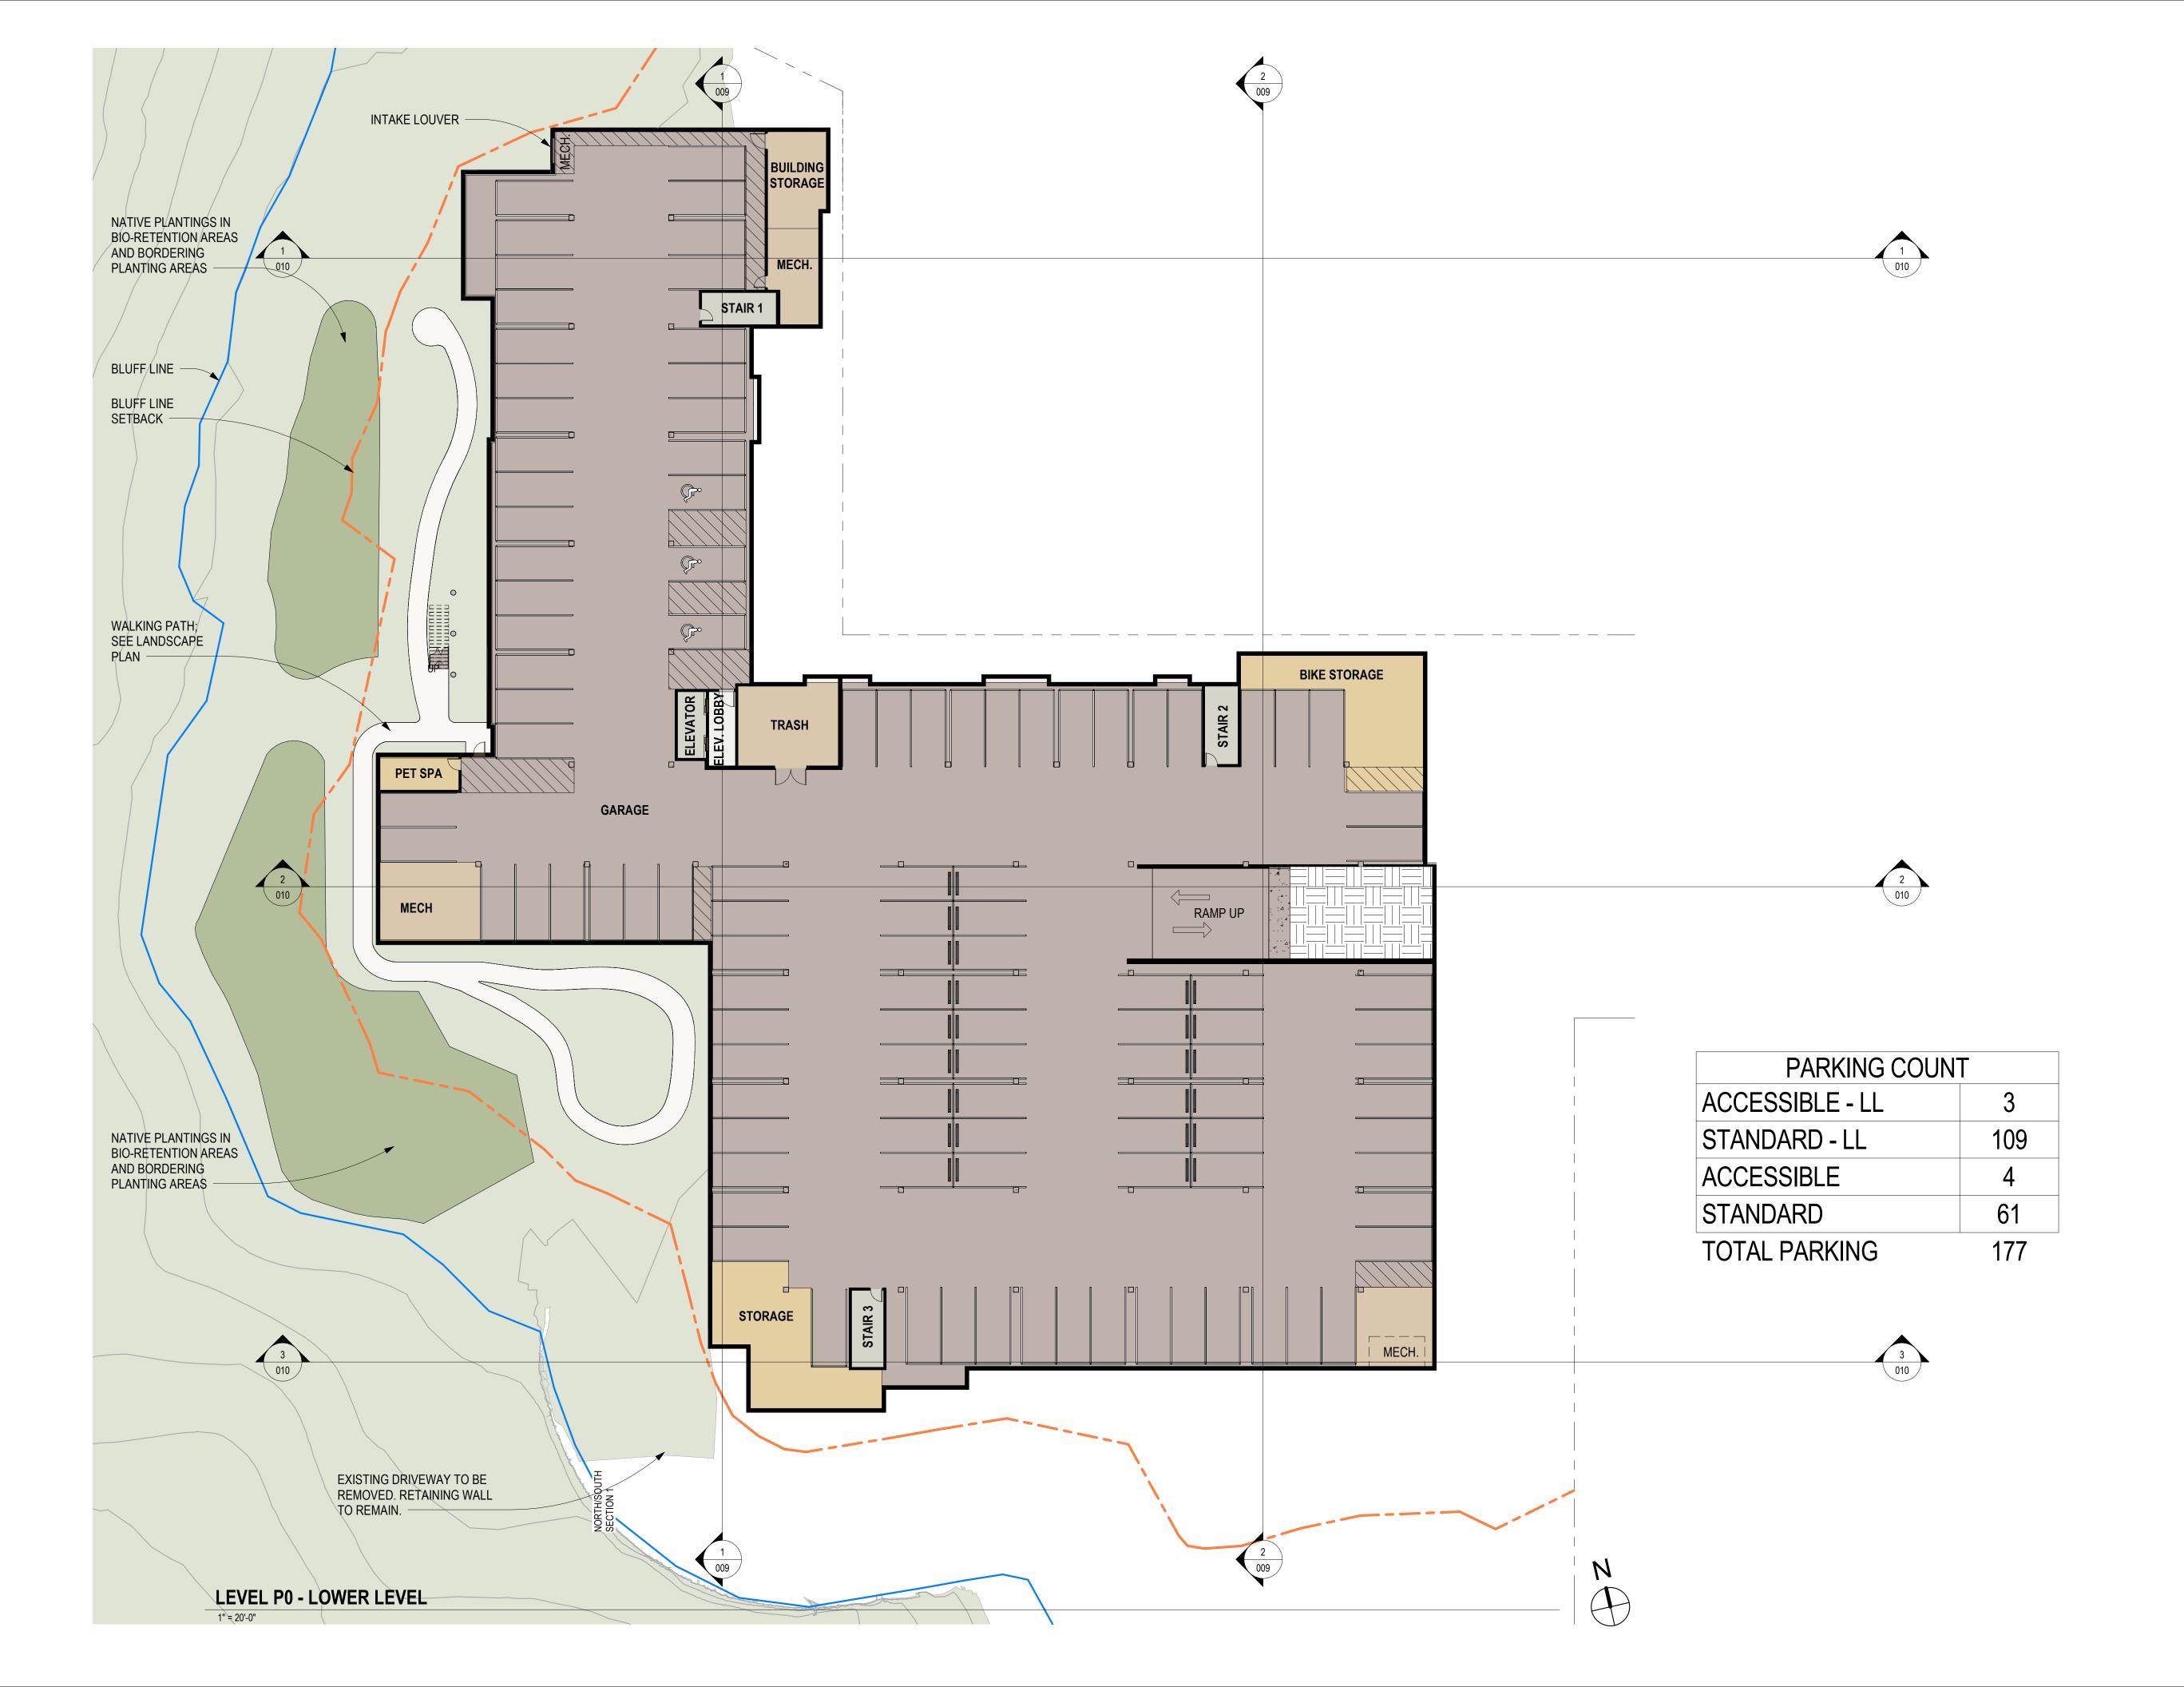CIVIL ENGINEER:
Advanced Engineering Concepts
Sean Bohan
1360 International Drive

Eau Claire, WI 54701 (715) 552-0330 www.aec.engineering DESIGN ARCHITECT: Harriss Associates, LLC

John Harriss, Owner 2836 44th Avenue, South Minneapolis, MN 55406 (612) 940-6427 jharriss@harrissarchitects.com

ARCHITECT OF RECORD:
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755 Prior Avenue North, Suite #301A
St. Paul, MN 55104 (612) 290-6523 brian@mdgarchitects.com





No.	Description	Date
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OSCEOLA, WI LEVEL P1

21059 Project number 06/02/23 Drawn by 002


PRELIMINARY

1" = 20'-0"



1" = 20'-0"

21059 06/02/23

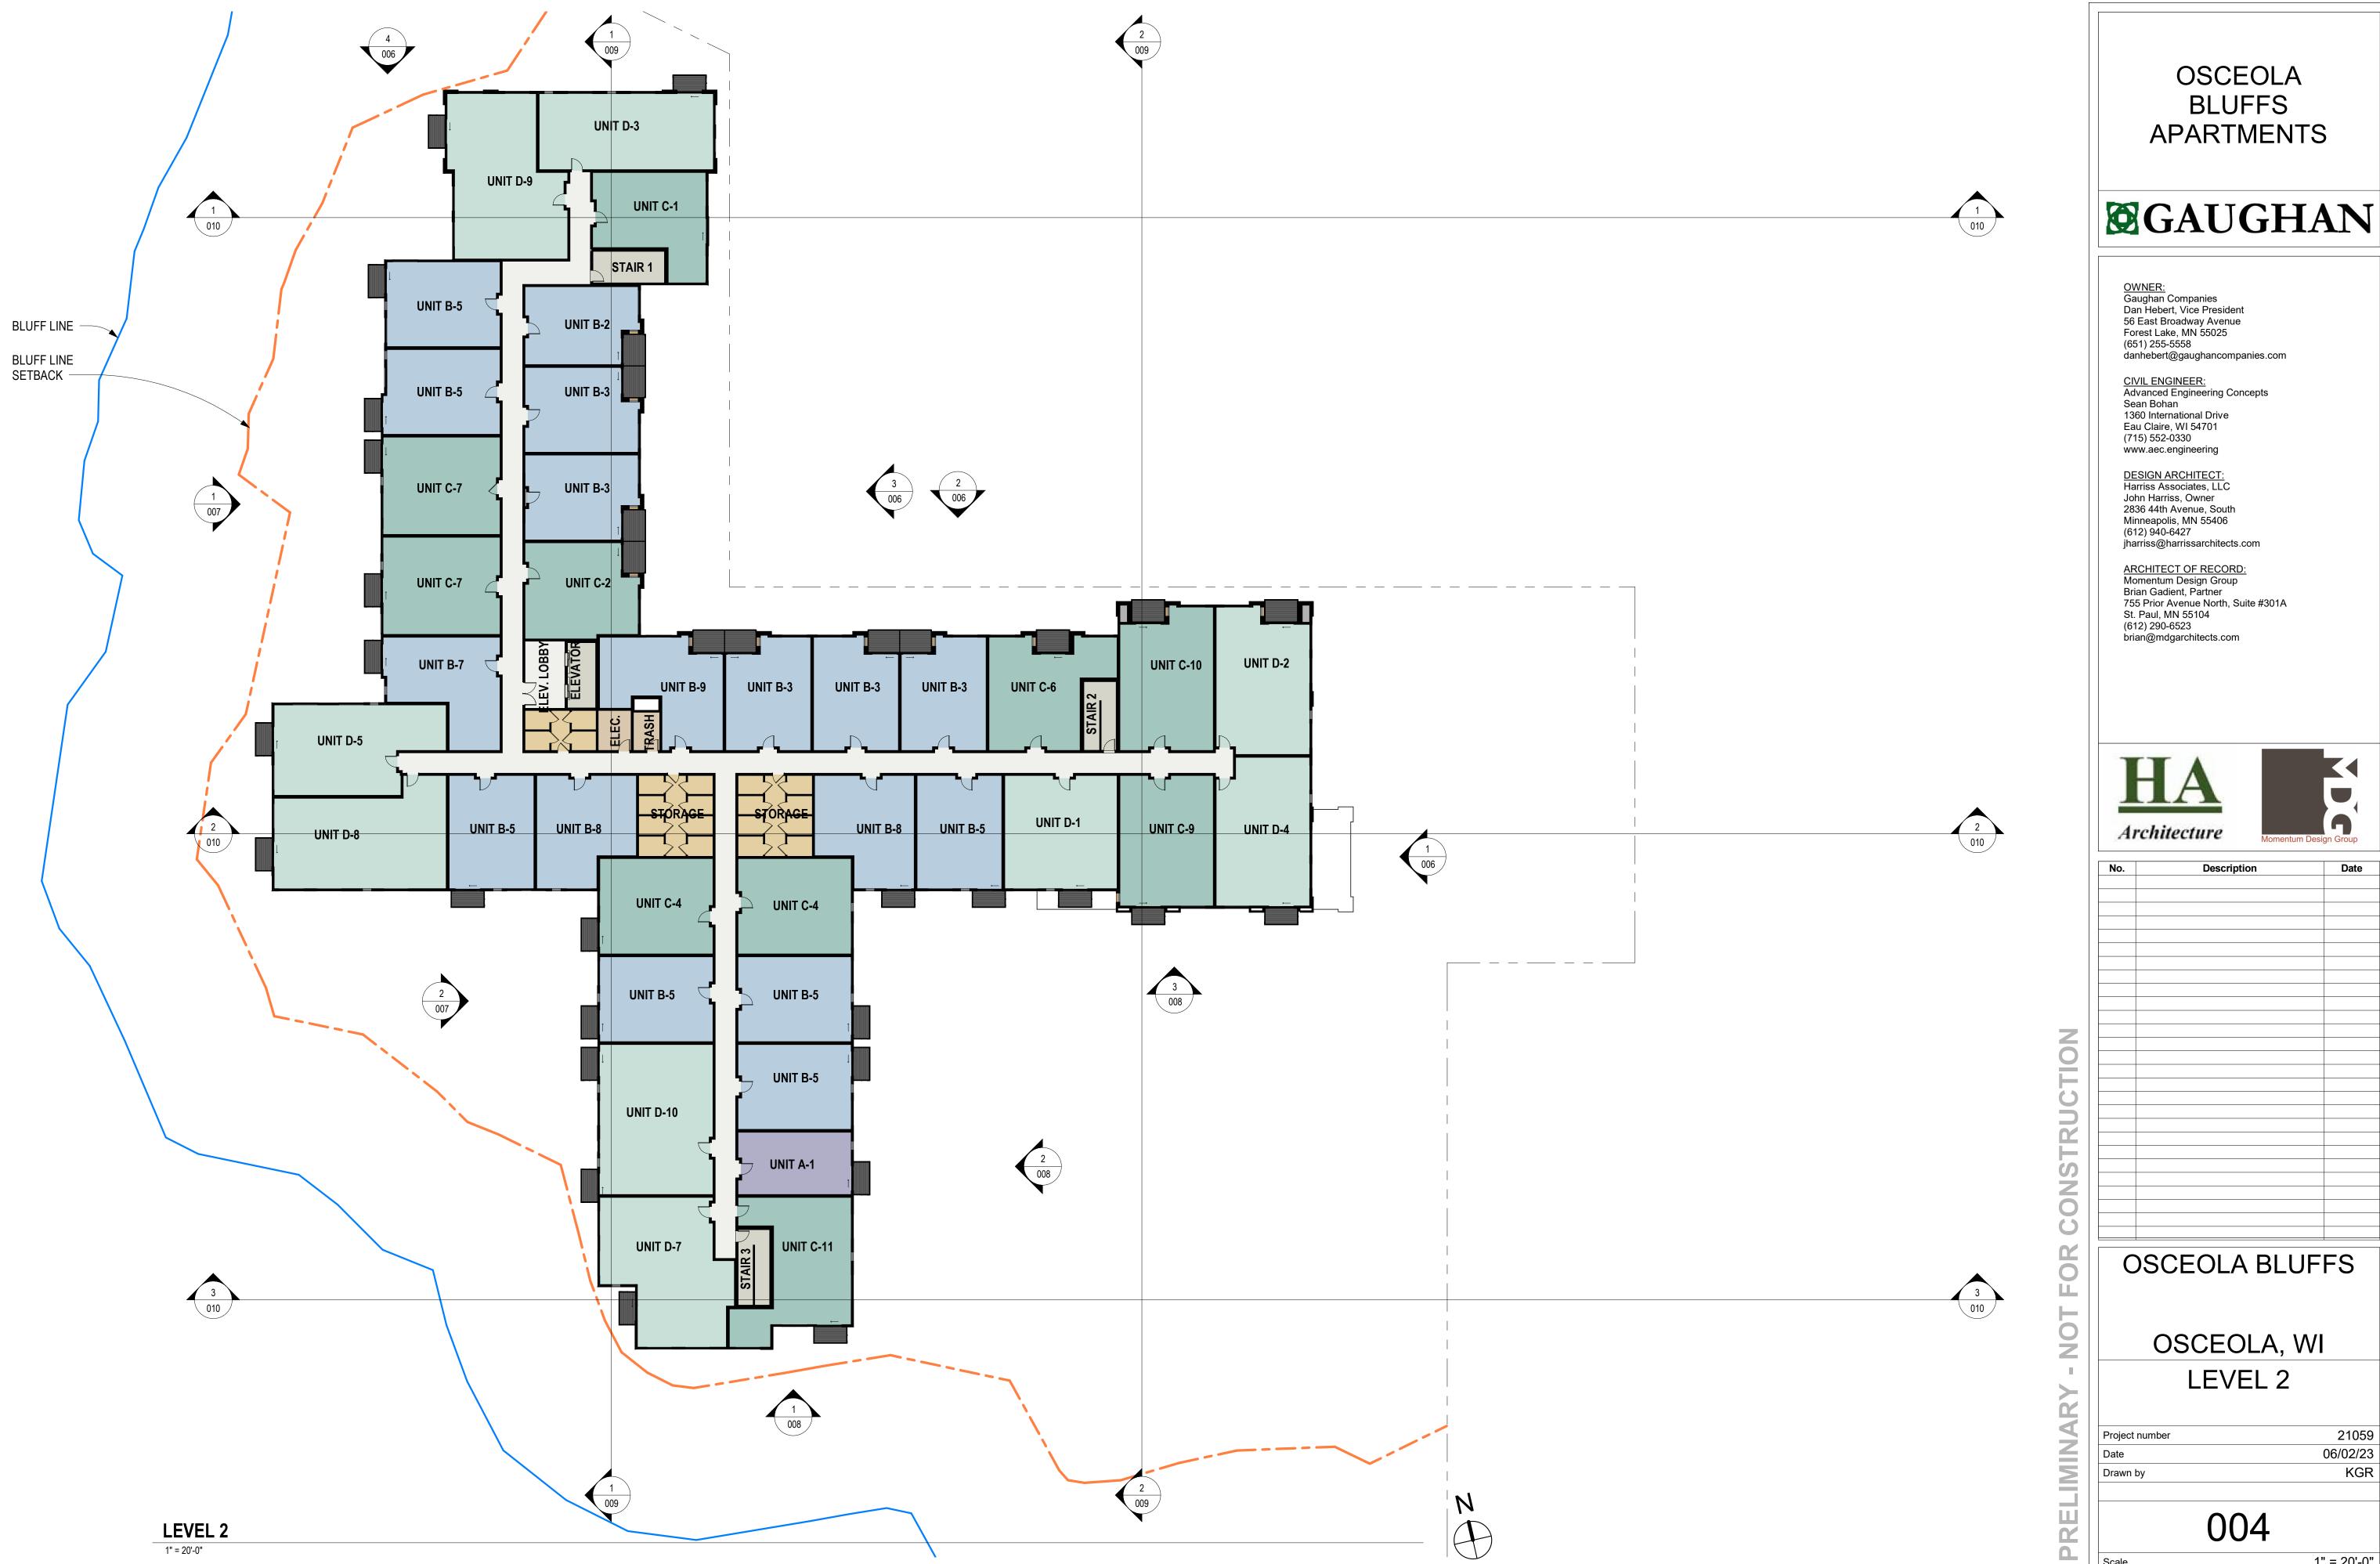

21059 06/02/23

1" = 20'-0"

OSCEOLA BLUFFS **APARTMENTS** 

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ARCHITECT OF RECORD:
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No.	Description	Date
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OS	<b>CEOLA BLU</b>	JFFS

OSCEOLA, WI LEVEL 3

21059 Project number 06/02/23 005

1" = 20'-0"



Architecture

OSCEOLA BLUFFS **APARTMENTS** 

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ARCHITECT OF RECORD:
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Date

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Description

OSCEOLA BLUFFS

OSCEOLA, WI SITE PLAN - BLUFF W/ EXISTING

Project number 04/18/23 Drawn by

**PRELIMINARY** 


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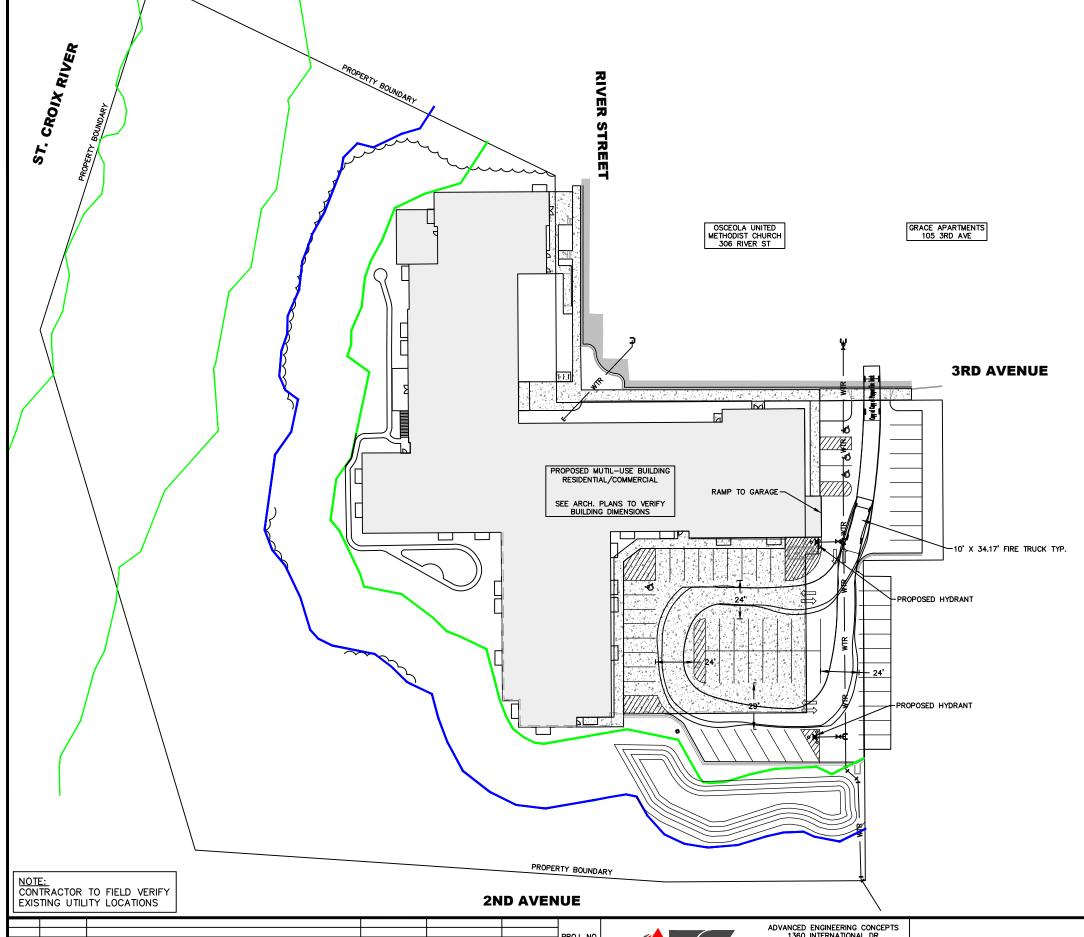
1" = 30'-0"

21059

Author





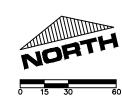

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NO. DATE REVISIONS DRAFTED BY DESIGN BY CHECKED



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FIRE TRUCK TURN EXHIBIT

OSCEOLA BLUFF APARTMENTS OSCEOLA VENTURES, LLC 301 RIVER STREET OSCEOLA, WI DWG NAME 21136 SITE DATE 4/2023

